

1260 LEXINGTON DRIVE, COLUMBIA, SC 29170

3

CONSRUCTION DOCUMENTS H59-N241-CL

JUNE 7, 2023

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|------------------|---------------------------------|
| SHEET NUMBER | SHEET NA |
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| ELECTRICA | L |
| E-001 | ELECTRICAL NOTES & LEGENDS |
| E-101 | ELECTRICAL PLANS |
| SHEET TOT | AL: 16 |

DESIGN TEAM

FIRE PROTECTION Mechanical Design Inc. 4403 Broad River Road, Columbia, SC 29210 Phone (803) 731-9834

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| RF | 0 | R ⁻ | |
|----|---|----------------|--|
| | | | |

| X |
|---|
| AME |
| |
| S & SYMBOLS CATIONS, & CLEARANCES CODES |
| |
| |
| |
| CHEDULES |
| |
| ND DETAILS |
| |
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| POND | |
|---|--|
| 1301 Gervais Street, Suite 1300 | |
| Columbia SC 29201 | |
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| SC. LICENSE NUMBERS: ARCHITECTURE: B-98107 ENGINEERING: CO1806 | |
| EOR/AOR SEAL | |
| SUTH CAROLEN | |
| ★ LORRAINE SANTANA WHITE COLUMBIA, SC 9392 | |
| STERED ARCHITE | |
| CLIENT INFORMATION | |
| | |
| MIDLANDS TECHNICAL COLLEGE | |
| PROJECT NAME | |
| MTC - | |
| SPRINGDALE | |
| AIRPORT | |
| CAMPUS | |
| H59-N241-CL | |
| 1260 LEXINGTON DRIVE, COLUMBIA, SC 29170 | |
| DRAWING ISSUE | |
| DATE | |
| | |
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| NOIL | |
| DESCRIPTION | |
| | |
| | |
| MARK | |
| DESIGNED BY: GB | |
| DRAWN BY: WLM CHECKED BY: GB | |
| SUBMITTED BY: GB DATE: JUNE 7, 2023 | |
| PROJECT #: 1230236 | |
| SHEET TITLE COVER SHEET | |
| | |
| | |
| | |
| | |
| SHEET NUMBER | |
| G-001 | |

ORIGINAL SHEET SIZE: 22" X 34"

| | | 1 | 2 |
|---|---|--------------------------------------|--|
| | MATERIALS | | ARCHITECTURAL GENERAL NOTES: |
| | | COMPACTED EARTH | THE DRAWINGS INDICATE THE GENERAL EXTENT OF WORK REQUIRED FOR THE FULL PERFORMANCE AND CONTRACT OF THE ENUMERATION OF PARTICULAR ITEMS OF WORK IN |
| | | ROCK | THE ENGINERATION OF PARTICULAR THEMOLOGY WORKING CONSTRUED TO EXCLUDE OTHER ITEMS NECESSARY OF THE CONTRACTOR IS RESPONSIBLE FOR THE COORDIN/ UNFINISHED OR INCOMPLETE CONDITION. |
| D | | ROCKFILL | 4. WORK SHALL CONFORM TO APPLICABLE INDUSTRY AND AND WORKMANSHIP AS WELL AS REQUIREMENTS IN THI THE SOURCES LISTED ABOVE SHALL BE BROUGHT TO T |
| | | SAND / MORTAR | THE CONTRACTOR SHALL PROTECT EXISTING, IN-PLACE THE CONTRACTOR SHALL PAY FOR AND COORDINATE T ONCE ON SITE, THE CONTRACTOR SHALL VERIFY EXISTI CONSTRUCTION DOCUMENTS. THE CONTRACTOR SHALL |
| | | CONCRETE | BEFORE COMMENCEMENT OF WORK. 8. DO NOT SCALE DRAWINGS; DIMENSIONS GOVERN, LARG CONTRACTOR SHALL NOTIFY THE ARCHITECT IN WRITIN |
| | | CONCRETE BLOCK(CMU) | DIMENSIONS NOTED AS 'HOLD' SHALL NOT VARY BY MOF SURFACE TO FINISHED SURFACE. WALL AND/OR CEILING ASSEMBLIES THAT ARE IDENTIFIE DETAILED LEDEIN. |
| | | EXTERIOR INSULATION FINISH SYSTEM | DETAILED HEREIN. 11. DIMENSIONS SHOWN ARE TO FACE OF STUD OR CMU (U 12. THE CONTRACTOR SHALL PERFORM WORK IN ACCORDA AGENCIES AND SHALL OBTAIN NECESSARY BUILDING AN |
| | | BRICK | 13. INTERIOR FINISH MATERIALS SHALL COMPLY WITH THE AGENCIES. 14. DISSIMILAR METALS SHALL BE ISOLATED FROM EACH OT |
| | | METAL-LARGE SCALE | NOTES APPEAR ON VARIOUS SHEETS FOR DIFFERENT S INDIVIDUAL SHEETS SHALL BE APPLIED TO RELATED DF A FINISH INDICATION ON A WALL SHALL MEAN THE ENTIF |
| С | IELO | METAL-SMALL SCALE | INDICATED. 17. WHEN NON-DIMENSIONED PARTITIONS APPEAR IN CONJ FRAME DETAILS DETERMINE THE LOCATION OF ADJACE 18. DETAILS NOT SHOWN ARE SIMILAR IN CHARACTER TO T |
| | | WOOD-FRAMING (CONTINUOUS) | INTENT CANNOT BE DETERMINED, CONSULT THE ARCHI |
| | | | PROVIDE ACCESS PANELS AS REQUIRED BY APPLICABL PLUMBING WORK. ACCESS PANELS SHALL BE CONCEAL TO PROCEEDING. PIPE DUCTS AND BUS DUCTS THAT PENETRATE FLOOR S |
| | | (DISCONTINUOUS) WOOD-FINISH | 21. FIFE DOCTS AND DOS DOCTS THAT FENETRATE FEOOR WILL PRESERVE THE MOISTURE RESISTIVENESS, FIRE F 22. DO NOT CUT INTO, REMOVE OR ALTER ANY STRUCTURA SPECIFICALLY NOTED OR SHOWN ON THE STRUCTURAL |
| | | ACOUSTICAL TILE | 23. PROVIDE EXPANSION AND CONTROL JOINTS IN WORK AS 24. INTERIOR PARTITION MOVEMENT CONTROL: A. VERTICAL CONTROL JOINTS FOR ANY WALL LENGTH |
| | | INSULATION BATT | DIRECTION, UNLESS NOTED OTHERWISE. B. PROVISIONS SHALL BE MADE IN THE DESIGN, FABRI FLOOR DEFLECTIONS OF THE STRUCTURE UNDER S a. TYPICAL ROOF/FLOOR MEMBERS: SPAN/36 |
| | | INSULATION RIGID | THE CONTRACTOR SHALL PLAN HIS/HER WORK TO PROVI TIMES, AND EXECUTE THE WORK IN SUCH A MANNER TO THE CONTRACTOR SHALL COORDINATE THE PHASING O |
| | | GYPSUM BOARD | APPLICABLE, WITH THE OWNER'S REPRESENTATIVE PRI |
| | | CERAMIC TILE | |
| В | | GLASS | |
| | | PLYWOOD | |
| | | PLASTER/ROCK LATH | |
| | | | |
| | SYMBOLS: | | |
| | SECTION NUMBER ¬ | | – ELEVATION – EL |
| | | | JMBER NUMBER 1 NU (TYP.) |
| | A-101 | 1 A-101 A-101 | $\begin{array}{c} 1 \\ A101 \end{array}$ |
| | └─ DWG. NO. WHERE SECTION IS DRAWN - | DWG. NO. W | DRAWN ELEVATION IS DRAWN EL |
| A | BUILDING SECTION MARK | WALL SECTION MA | <u>INTERIOR ELEVATION MARK</u> INTERIOR ELEV |
| | PLAN SYMBOLS: | | - PARTITION TYPE - CEILING T |
| | ID# ID# ROOM NAI | | SUBSCRIPT TYPE (AS -A1-X REQ) (?) CEILING H (1t 12'-0" A.F.F.) |
| | NEW & EXISTING ROOM T | | PARTITION TYPEKEYNOTECEILING TAG(REFER TO PARTITIONTAG(TYPE & HEIGHT) |
| | | LOUVER TAG | SHEET FOR DESCRIPTION |

| 3 |
|---|
| 0 |
| |

| ORK. THE DRAWINGS ARE NOT INTENDED TO INDICATE OR DESCRIBE ALL OMPLETION OF THE REQUIREMENTS OF THE CONTRACT DOCUMENTS. ONE PORTION OF THE CONTRACT DOCUMENTS SHALL NOT BE R IMPLIED THEREFROM. |
|--|
| ATION OF THE WORK SO THAT NO WORK SHALL BE LEFT IN AN |
| D MANUFACTURER'S PUBLISHED STANDARDS FOR QUALITY OF MATERIALS E CONSTRUCTION DOCUMENTS. ANY CONFLICTING REQUIREMENTS OF THE ARCHITECT'S ATTENTION PRIOR TO PROCEEDING WITH THE WORK. E, AND NEW WORK. |
| THE REMOVAL AND LEGAL DISPOSAL OF MATERIALS AND RUBBISH. ING CONDITIONS THAT CORRESPOND TO THOSE SHOWN ON THE L NOTIFY THE ARCHITECT IN WRITING OF ANY DIFFERING CONDITIONS |
| GE SCALE DETAILS GOVERN OVER SMALL SCALE DETAILS. THE NG OF ANY DIFFERING CONDITIONS BEFORE COMMENCEMENT OF WORK. RE THAN 1/8" FROM SIDE TO SIDE OR FROM FRONT TO BACK, FINISHED |
| ED WITH A FIRE RESISTIVE RATING SHALL BE CONSTRUCTED AS |
| J.N.O.). ANCE WITH APPLICABLE CODES, ORDINANCES AND REGULATORY ND FIRE PERMITS FROM AUTHORITIES HAVING JURISDICTION. REQUIREMENTS OF APPLICABLE CODES, ORDINANCES AND REGULATORY |
| THER TO AVOID GALVANIC CORROSION. SYSTEMS AND MATERIALS. SHEETS ARE TO BE REVIEWED AND NOTES ON RAWINGS AND DETAILS. |
| RE LENGTH AND HEIGHT OF WALL IS TO BE FINISHED OR FIRE-RATED AS |
| JUNCTION WITH DOOR OPENINGS, THE DOOR WIDTH AND THE DOOR INT WALLS AND FRAMES. |
| HOSE DETAILED. WHERE SPECIFIC DIMENSIONS, DETAILS OR DESIGN |

HOSE DETAILED. WHERE SPECIFIC DIMENSIONS, DETAILS OR DESIGN ITECT BEFORE PROCEEDING WITH THE WORK.

ND ELECTRICAL FLOOR AND WALL SLEEVES INCLUDING CONDUITS WITH ON, STRUCTURAL AND ARCHITECTURAL DRAWINGS. LE CODES AND AS REQUIRED FOR MECHANICAL EQUIPMENT AND

LED AND LOCATIONS SHALL BE REVIEWED WITH THE ARCHITECT PRIOR

SLABS OR WALL PARTITIONS SHALL BE INSTALLED IN A MANNER THAT RATING, AND STRUCTURAL INTEGRITY OF THE BUILDING. AL MEMBER OR PORTION OF THE FLOOR SYSTEM UNLESS IT IS DRAWINGS.

AS PER PRODUCT MANUFACTURER'S STANDARDS.

"H ARE TO OCCUR AT NOT MORE THAN 30'-0" O.C. IN THE HORIZONTAL

RICATION, AND INSTALLATION OF INTERIOR PARTITIONS FOR TYPICAL SUPERIMPOSED LOADS AS FOLLOWS:

60 BUT NOT LESS THAN 1/2".

OVIDE ADEQUATE PROTECTION FOR PERSONS AND PROPERTY AT ALL O AVOID ANY HAZARD TO PERSONS AND PROPERTY AS NECESSARY. OF THE WORK TO BE PERFORMED IN OR ABOUT EXISTING FACILITIES, IF RIOR TO START OF SUCH WORK.

| AFF | ABOVE FINISHED FLOOR | FDN | FOUNDATI |
|----------------------|--|-------------------|------------------------|
| ADAAG | AMERICAN W/ DISABILITIES | GA | GAGE / GA |
| ADJ | ACCESSIBILITY GUIDELINES ADJUST/ ADJUSTABLE | GALV GFCI | GALVANIZI GOVERNM |
| ACT | ACOUSTICAL CEILING TILE | | CONTRAC |
| | ANODIZED ALUMINUM | GFGI | GOVERNM |
| AL / ALUM. APPROX | APPROXIMATE | GL | GOVERNM GLASS / GI |
| AR/ARCH | ARCHITECTURAL | GOVT | GOVERNM |
| AT / FP | ANTI TERRORISM / FORCE PROTECTION | GYP GWB | GYPSUM GYPSUM V |
| AVG | AVERAGE | HDW | HARDWAR |
| A/V | AUDIO/VISUAL | HGT | HEIGHT |
| BLKG BD | BLOCKING BOARD | HM HORIZ | HOLLOW M |
| BTM | BOTTOM | HB | HOSE BIBE |
| B/O | BOTTOM OF | HVAC | |
| BLDG CFCI | BUILDING CONTRACTOR FURNISHED | IMP | AIR CONDI |
| | CONTRACTOR INSTALLED | IN | INCH |
| CFMF | COLD FORMED METAL FRAMING | INSUL INT | INSULATIC |
| CPT | CARPET | JAN | JANITOR |
| CLG | CEILING | JC | JANITOR'S |
| CLG HT CTR | CEILING HEIGHT CENTER | JT KP | JOINT KICK PLAT |
| ¢ | CENTER LINE | IXF | |
| СТ | CERAMIC TILE | LAM | LAMINATE |
| CLR CO | CLEAR CLEANOUT | LDG LAV | LANDING LAVATORY |
| COL | COLUMN | LH | LEFT HAND |
| CONC | CONCRETE | LHR | |
| CORR CMU | CORRIDOR CONCRETE MASONRY UNIT | LGT LT | LENGTH LIGHT |
| CONF | CONFERENCE | LTG | LIGHTING |
| CONST | CONSTRUCTION | LONG LVR | LONGITUD LOUVER |
| CONT CONTR | CONTINUOUS CONTRACTOR | | LOUVER |
| CJ | CONTROL JOINT | MAS | MASONRY |
| CY | | MO MGR | MASONRY MANAGER |
| DET DIA | DETAIL DIAMETER | MANUF | MANUFAC |
| DIM | DIMENSION | MATL | MATERIAL |
| DISP DN | DISPENSER DOWN | MAX MECH | MAXIMUM MECHANIC |
| DS | DOWNSPOUT | MTL | METAL |
| DESC | DESCRIPTION | MWP | METAL WA |
| DWG EA | DRAWING EACH | MB MIN | MINI BLINC MINIMUM |
| ELEC | ELECTRICAL OR ELECTRIC | MIR | MIRROR |
| EL | | MISC N.I.C. | MISCELLAI NOT IN CO |
| EWC EP | ELECTRIC WATER COOLER EPOXY PAINT | NO. (#) | NUMBER |
| ENGR | ENGINEER | NTS | NOT TO SC |
| EOS EQUIP | EDGE OF SLAB EQUIPMENT | NFPA | NATIONAL PROTECTI |
| EQ | EQUAL | O.C. | ON CENTE |
| EXIST | EXISTING | OFCI | OWNER FL |
| EXP EJ | EXPOSED EXPANSION JOINT | OFGI | OWNER FL |
| EXP ST | EXPOSED TO STRUCTURE | | GOVERNM |
| EXT FDC | EXTERIOR FIRE DEPARTMENT | o.h. Opng | OPPOSITE OPENING |
| FDC | CONNECTION | OPP | OPPOSITE |
| FT | FEET | O.D. | |
| FV FIN | FIELD VERIFY FINISH | OSHA | OCCUPATI AND HEAL |
| FIN | FINISHED FLOOR | OVHD / OH | OVERHEAD |
| FE | FIRE EXTINGUISHER | O / D PT / PNT | OVERFLOV PAINT |
| FEC FP | FIRE EXTINGUISHER CABINET | PT/PNT PR | PAINT PAIR |
| FLR | FLOOR | PNL | PANEL |
| FD | FLOOR DRAIN | PART PLAS | PARTITION PLASTIC |
| F / O FTG | FACE OF | PLAS | PLASTIC L |


4

ARCHITECTURAL ABBREVIATIONS:

LEVATION JMBER YP.)

(TYP.) BY DETAIL ∖**A-101**/

WG. NO. WHERE LEVATION IS DRAWN VATION MARK

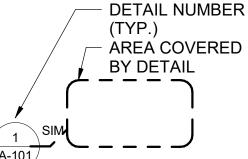

- DWG. NO. WHERE DETAIL IS DRAWN

ГҮРЕ HGT

1i <u>EQUIPMENT</u>

<u>TAG</u>

<u>TAG</u>

REVISION NORTH ARROW

PLAN NORTH

CALLOUT HEAD

VIEW TITLES:

DETAIL IDENTIFIER (MODULE LETTER AND NUMBER)

FTG



FOOTING

FLOOR PLANS, ELEVATIONS, SECTIONS AND DETAIL VIEWS TITLE

ΡL

PT

PSF

PSI

Q.T.

RAF

RCPT

REF

REINF

REQ'D

REV

R/D

RH

RHR

RM

RO

RB

SG

SC

SCHED

SECT

SSK

SIM

STC

SFRM

SQ

ST

S.S.

STD

STL

STOR

STR

TEL

THK

TLT

Τ/Ο

TYP

U.L.

UNFIN

U.N.O.

VERT

VEST

VCT

VCB

WDT

W /

WC

WD

WDW

W / O

WRGB

YD

SUSP

SPEC(S)

PEMB

PRE-FAB

PLMB

PLYWD.


DATION GAUGE NIZED NMENT FURNISHED ACTOR INSTALLED RNMENT FURNISHED RNMENT INSTALLED / GLAZING RNMENT JM WALL BOARD /ARE W METAL NTAL IBB NG VENTILATION & NDITIONING ATED METAL PANEL TION DR R'S CLOSET ATE TE DRY AND AND REVERSE ١G UDINAL OLTAGE IRY IRY OPENING SER ACTURER IAL JM NICAL WALL PANEL IND М LANEOUS CONTRACT SCALE IAL FIRE CTION ASSOCIATION NTER R FURNISHED ACTOR INSTALLED R FURNISHED NMENT INSTALLED ITE HAND IG ITE DE DIAMETER PATIONAL SAFETY ALTH ACT IEAD LOW DRAIN

ION

PLAM


PLASTIC LAMINATE

PLATE PLUMBING PLYWOOD PORCELAIN TILE LBS. OR # POUNDS POUNDS / SQUARE FOOT POUNDS / SQUARE INCH PRE-ENGINEERED METAL BUILDING PREFABRICATED QUARRY TILE RAISED ACCESS FLOOR **RECEPTIONIST / RECEPTION** REFERENCE **REINFORCEMENT /** REINFORCED REQUIRED **REVISIONS / REVISED** ROOF DRAIN RIGHT HAND RIGHT HAND REVERSE ROOM ROUGH OPENING RUBBER BASE SAFETY GLASS / GLAZING SEALED CONCRETE SCHEDULE SECTION SERVICE SINK SIMILAR SOUND TRANSMISSION CLASS SPECIFICATION SPRAYED FIRE **RESISTIVE MATERIAL** SQUARE STAIN STAINLESS STEEL STANDARD STEEL STORAGE STRUCTURAL SUSPENDED TELECOMM TELECOMMUNICATIONS TELEPHONE THICK / THICKNESS TOILET TOP OF TYPICAL UNDERWRITERS LABORATORIES UNFINISHED UNLESS NOTED OTHERWISE VERTICAL VESTIBULE VINYL COMPOSITION TILE VINYL COVE BASE WIDTH WITH WATER CLOSET WOOD WINDOW WITHOUT WATER RESISTANT GYPSUM BOARD YARD

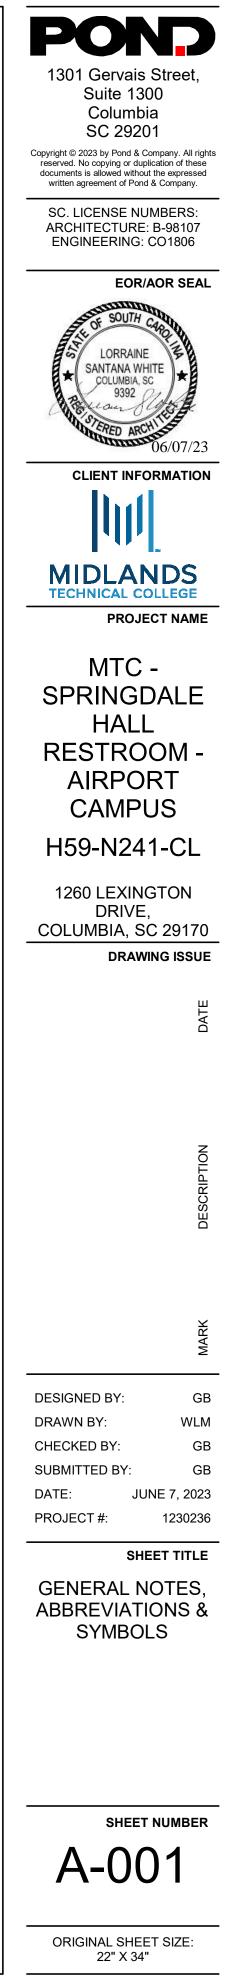








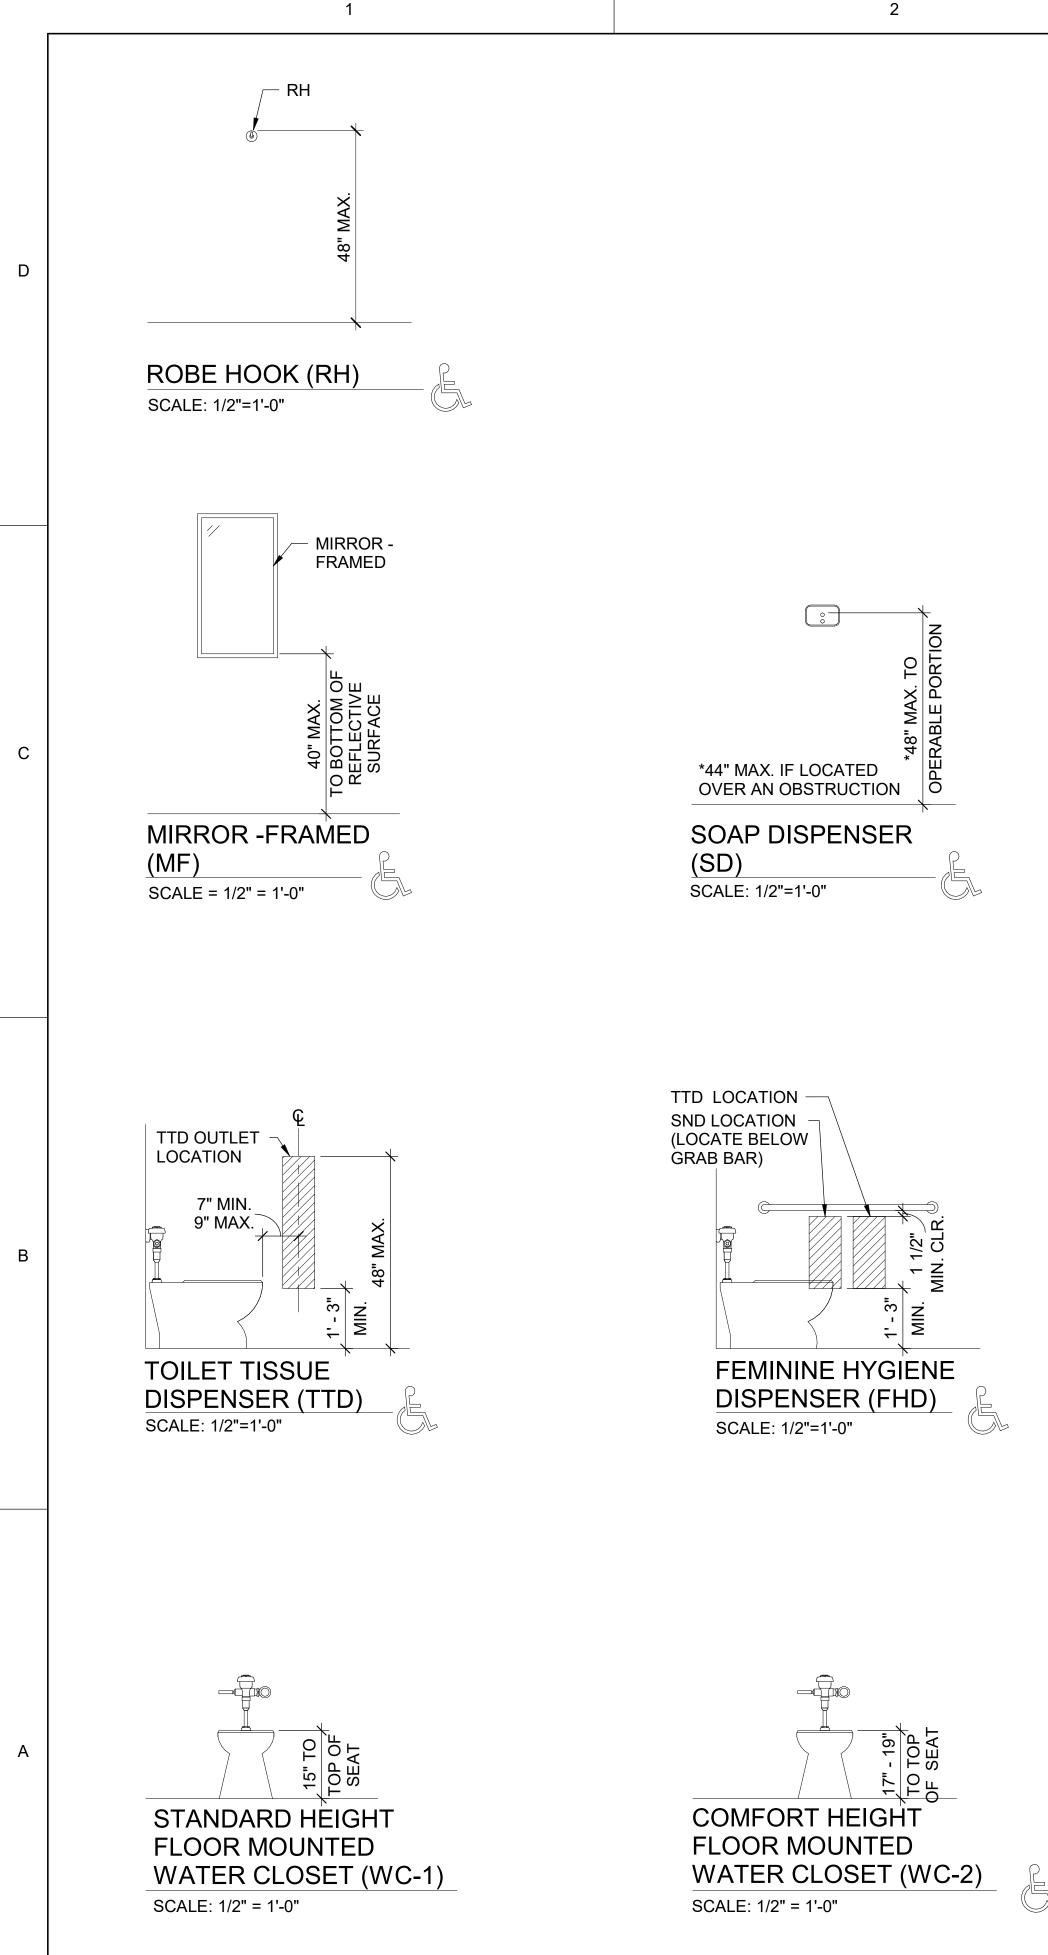




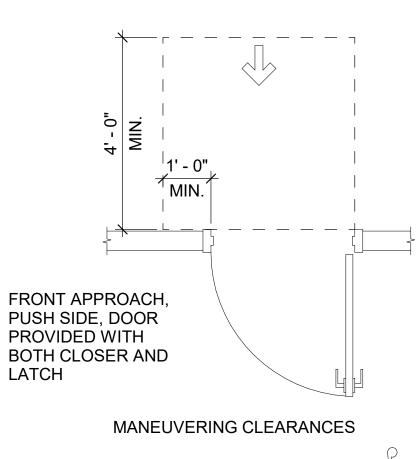


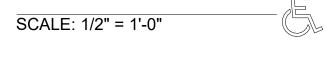

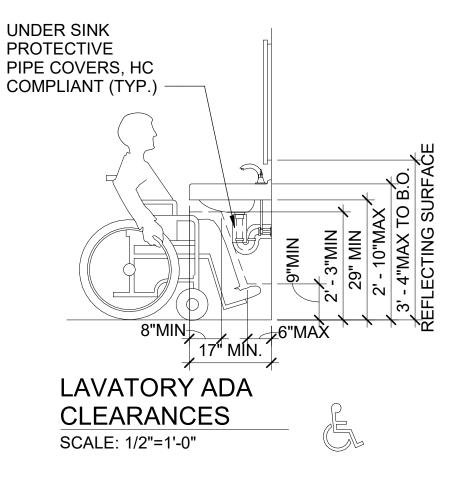


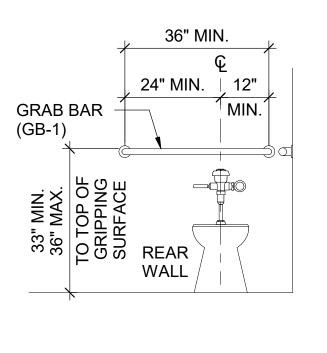




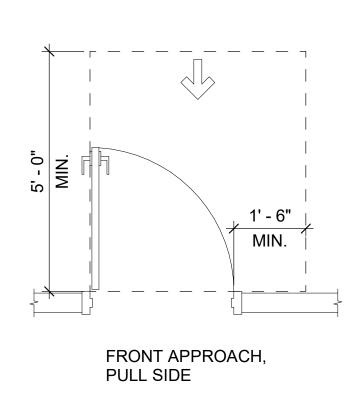




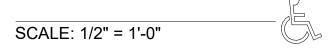

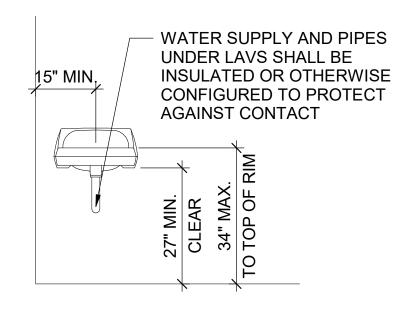





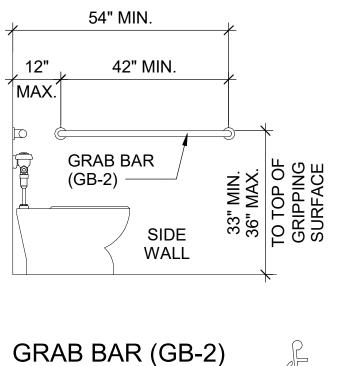



SCALE: 1/2"=1'-0"


SHEET NOTES:


- THIS SHEET INDICATES TYPICAL AND ACCESSIBLE MOUNTING HEIGHTS AND ADDITIONAL CRITERIA.
- 2. THE ACCESSIBLE CRITERIA INDICATED ON THIS SHEET ARE IN COMPLIANCE WITH THE ADA STANDARDS FOR ACCESSIBLE DESIGN (2010) AND ICC A117.1-2017.
- 3. DETAILS ON THIS SHEET INDICATING ACCESSIBLE **REQUIREMENTS ARE MARKED WITH THE "INTERNATIONAL** SYMBOL OF ACCESSIBILITY".
- 4. VERIFY MANUFACTURER'S RECOMMENDED ACCESSIBLE MOUNTING LOCATIONS WITH THOSE LISTED ON THIS SHEET.
- 5. CONTRACTOR TO INFORM ARCHITECT OF ANY DISCREPANCY WITH OTHER DRAWINGS PRIOR TO INSTALLATION.


"INTERNATIONAL SYMBOL OF ACCESSIBILITY"

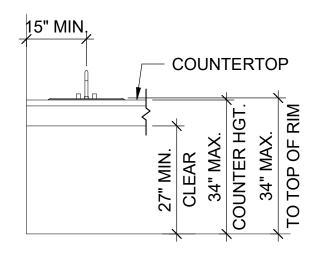

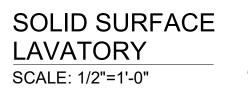

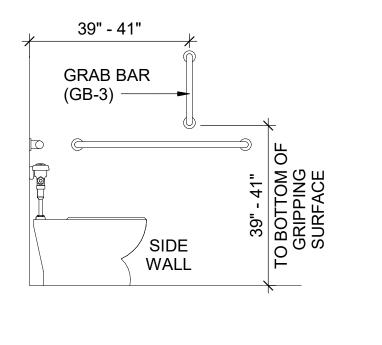

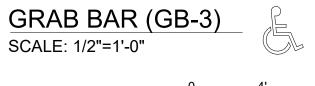

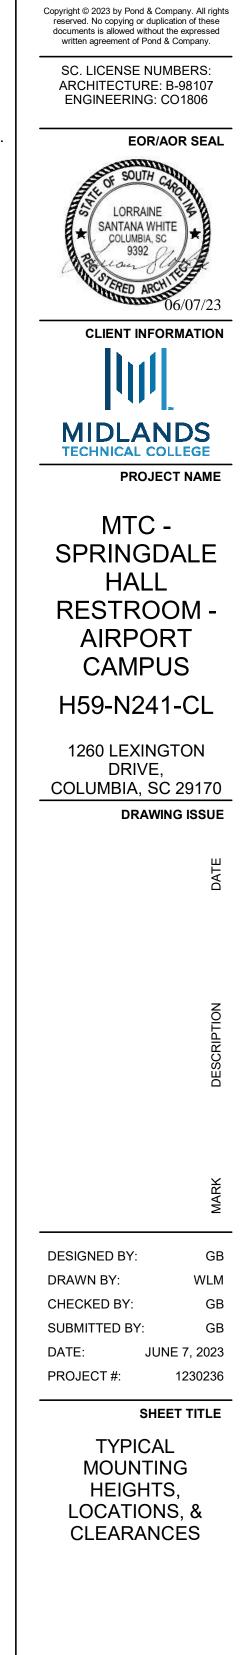

SHEET NUMBER

A-002

ORIGINAL SHEET SIZE: 22" X 34"

POND

1301 Gervais Street Suite 1300

Columbia

SC 29201

CONSRUCTION DOCUMENTS

SCALE: 3/16" = 1'-0"

PLAN NORTH

| 2023 | Edition |
|------|---------|

LIST OF APPLICABLE CODES:

2

| INTERNATIONAL BUILDING CODE (IBC), 2021 EDITION WITH SCBC MODIFICATIONS |
|--|
| INTERNATIONAL EXISTING BUILDING CODE (IEBC), 2021 EDITION |
| INTERNATIONAL FIRE CODE (IFC), 2021 EDITION WITH SCBC MODIFICATIONS |
| INTERNATIONAL ENERGY CONSERVATION CODE (IECC), 2009 EDITION |
| INTERNATIONAL MECHANICAL CODE (IMC), 2021 EDITION WITH SCBC MODIFICATION |
| INTERNATIONAL PLUMBING CODE (IPC), 2021 EDITION WITH SCBC MODIFICATIONS, |
| AND THE FOLLOWING INSERTIONS: |
| - SECTION 305.4.1, INSERT "18" AND INSERT "18" |
| - SECTION 903.1, INSERT "8" |
| NATIONAL ELECTRICAL CODE (NEC) 2020 EDITION WITH SCROMODIELCATIONS |


| TYPE OF PROJECT: | | | |
|---|-----------------------|--|--------------------------|
| Alteration (IEBC Chaps. 7, 8 &9) | ldition (IEBC Chap. 1 | 1) Change of (| Occupancy (IEBC Chap. 10 |
| METHOD OF COMPLIANCE: | Option 1: Pre | escriptive Compliance | Method (IEBC Chapter 5) |
| (Check only one Option and all items that apply under that Option.) | Alteration I | _evel 1, minor including _evel 2, reconfiguration | |
| | | • | e Method (IEBC Chap. 13) |
| Original Building Code and Edition Applicable | at time of Construct | ion <u>:</u> | |
| Existing Sprinkler System? | | 🛛 Yes | 🗌 No |
| Existing Fire Alarm System? | | 🗌 Manual | 🖂 Auto |
| Seismic Evaluation Required? | | 🗌 Yes | 🖂 No |
| Major Facility Project? (See §48-52-810(10)(a | a)) | 🗌 Yes | 🖂 No |
| Change of Occupancy: Existing Occupancy Classification(s): New Occupancy Classification(s): | | Yes | 🛛 No |
| Historic Building (IEBC Chapter 12): | n 🗌 Re | Yes [| ⊠ No] Reconstruction |

1

С

D

Α

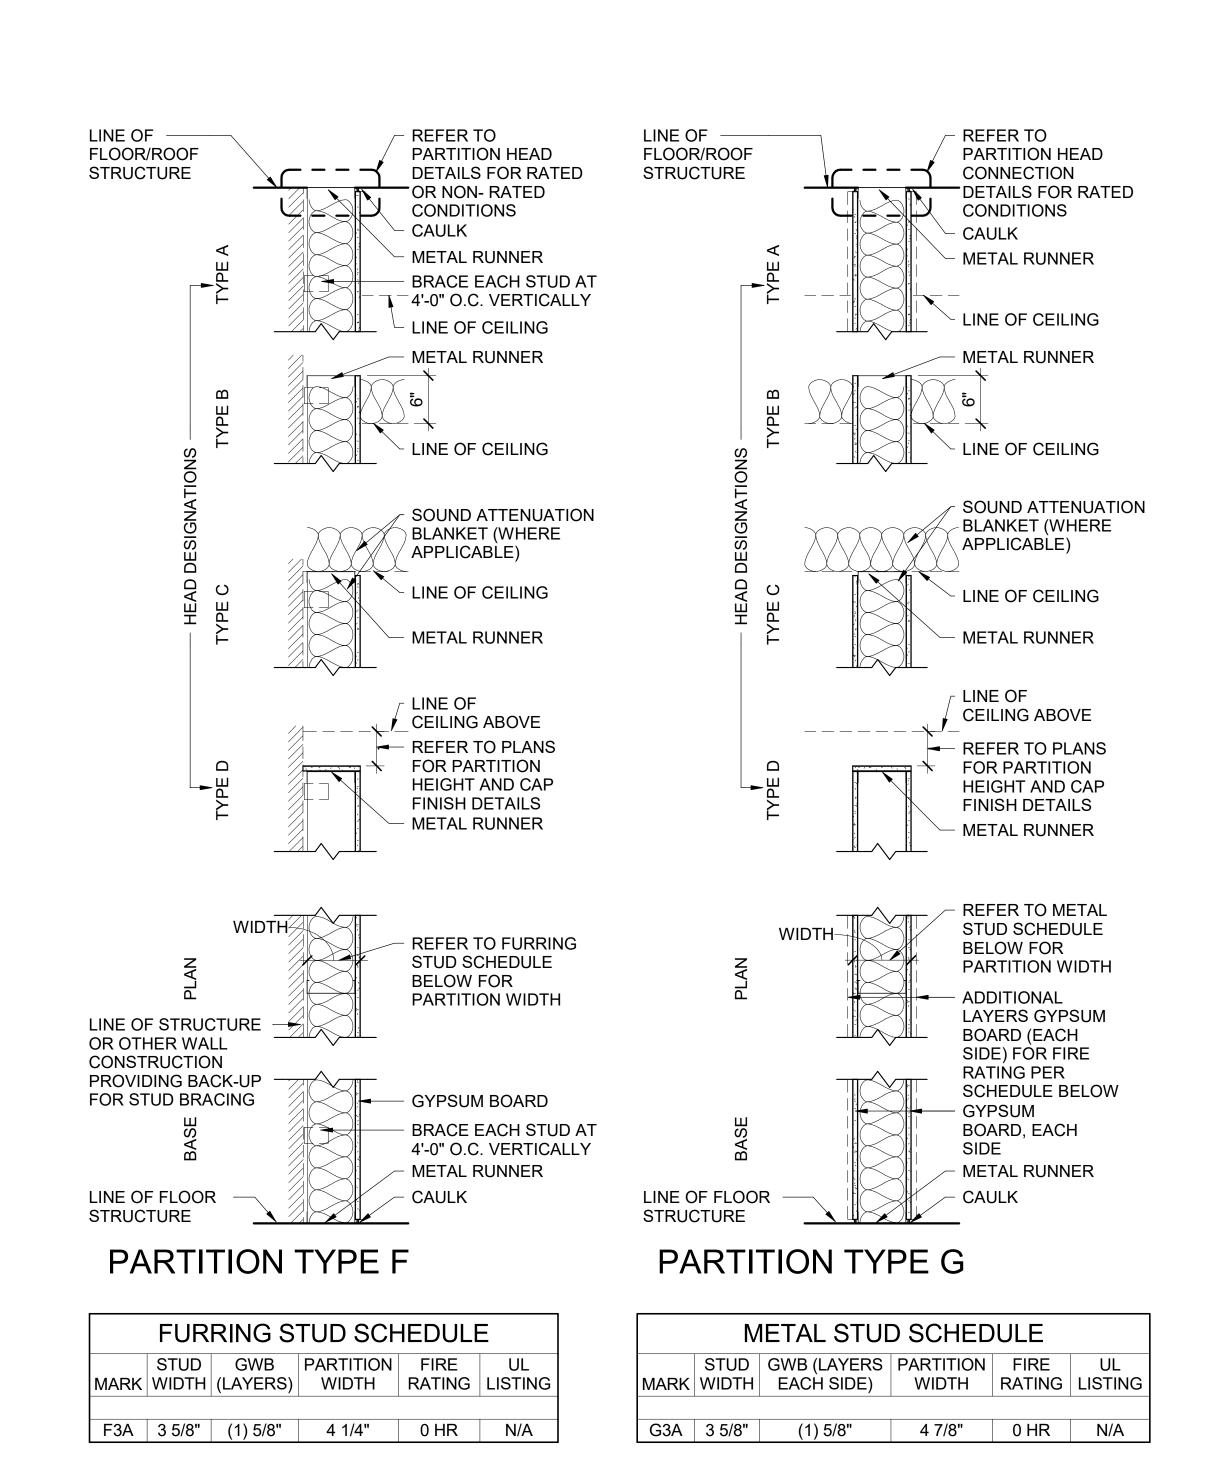

SERT "8" NATIONAL ELECTRICAL CODE (NEC), 2020 EDITION WITH SCBC MODIFICATIONS ICC A117.1 ACCESSIBLE AND USABLE BUILDINGS AND FACILITIES, 2017 EDITION

| | - | | | - • - | | MENTS OF APPLICABLE | Suite 1300 Columbia |
|--|--|---|---|--|-------------|--|--|
| 2. | | RUCTIO | | | 101 | MENCLATURE" FOR | SC 29201 Copyright © 2023 by Pond & Company. All rights |
| | SYMBO | DLS USE | D TO ID | ENTIFY | AD | DITIONAL REQUIREMENTS | reserved. No copying or duplication of these documents is allowed without the expressed written agreement of Pond & Company. |
| 3. | "LINE C | OF STRU | CTURE" | INDICA | TE | D FOR EACH PARTITION IS | SC. LICENSE NUMBERS: |
| | | | | | | S NOT INDICATE EXACT R GEOMETRY. | ARCHITECTURE: B-98107 ENGINEERING: CO1806 |
| 4. | | | | | | NS OF PARTITIONS ARE TO NOTED OTHERWISE. | EOR/AOR SEAL |
| 5. | WHER | E A CLEA | | NING DI | ME | NSION IS INDICATED, THE | STATISTICS OUTH |
| | | SION IS I ED SURF | | REDFA | CE | TO-FACE BETWEEN | STATUS SOUTH CAROL |
| 6. | | | | | | MINIMUM STUD DESIGN | |
| | HEIGH | TS DEFL | ECTION | CRITE | RIA | FOR GYPSUM BOARD. | Barrow Super |
| 7. | | | | | | AND UL TEST NUMBERS MANUFACTURER OF | WO STERED ARCHITEST |
| | COMPO | ONENTS | ACTUA | LLY USE | ED. | | |
| 8. 9. | | | - | - | | RE PROTECTION RATINGS. | |
| | WITH L MINIMU | | PER AH. | J AS RE | QU | IRED. IBC CHAPTER 7 AT | |
| 10. | - | - | S IN RA | TED PAI | RTI | TIONS AND CONNECTIONS | L.O.F |
| | | | | | | PORTIONS OF THE WORK TO | MIDLANDS |
| | RECON | /MENDE | D DETA | ILS AND |) IN | I COMPLIANCE WITH | PROJECT NAME |
| 11. | | | | | | REQUIREMENTS. RD, BACKER BOARD AND | |
| | BASE E | BOARD T | O CONF | FORM T | O F | REQUIREMENTS FOR FIRE | MTC - |
| 12. | | GS AND / DE WATE | | | | PE GYPSUM BOARD AT | SPRINGDALE |
| | | | | | | OM FINISH SCHEDULE TO | HALL |
| 13. | INSTAL | L BLOC | KING OF | R BACKE | ER | MATERIAL FOR | RESTROOM - |
| | - | - | | | | ALL HUNG ITEMS OR DOCUMENTS. ALL | AIRPORT |
| | BLOCK | ING TO I | BE FIRE | RETAR | DA | NT TREATED. | CAMPUS |
| 14. | | | | - | | D TO EXTEND TO THE DECK | H59-N241-CL |
| | WITHIN | IA 1/4" N | /AXIMU | M TOLE | RA | NCE TO THE SHAPE OF THE | |
| | - | - | | - | | F THE GYPSUM BOARD | 1260 LEXINGTON DRIVE, |
| 15 | | LEXIBLE | | | ര ' | 24" VERT. TO HOLD BATT | COLUMBIA, SC 29170 |
| | INSULA | ATION FC | DR ARE | AS WITH | ĨO | JT GYPSUM WALLBOARD. | DRAWING ISSUE |
| 16. | | | | | | O THAT THE CLEARANCE | |
| 47 | GYPSL | JM BOAR | D DOES | S NOT E | XC | EED 1/8". | DATE |
| 17. | | | | | | OARD AT INTERIOR UM AND 1/2" MAXIMUM | |
| | | | | | | AND IS TO BE SEALED FOR | |
| | SEALA | NT. | | | | | |
| 18. | | | | | | ATION BLANKETS PROVIDE S ON CEILING TO 2'-0" ON | Z |
| | - | - | | - | | T WALLS WITH SOUND | IPTIC |
| | REFER | TO INTE | RIOR F | INISH S | C⊦ | IDING TO STRUCTURE. EDULE FOR WALL FINISHES. | DESCRIPTION |
| 20. | REFER PARTII | | TITION | TYPE M | O | DIFIERS FOR STC RATED | ä |
| PA | | I TYPE N | OMENC | LATUR | E | | |
| | | | | | | | |
| | 1 \$6 A | <u>-1</u> | | | | | MARK |
| | | - PAR | | | | IFIER (WHERE APPLICABLE) | ₩ ₩ |
| | | | FITION H | | | DITION RE SIZE (SEE SCHEDULE) | DESIGNED BY: GB |
| | | — PAR | TITION ⁻ | ΓΥΡΕ | | , , , , , , , , , , , , , , , , , , , | DRAWN BY: WLM |
| | | | | RATING | ` | HERE APPLICABLE) | CHECKED BY: GB |
| | RTITION | | | | | ARTITION HEAD CONDITION | SUBMITTED BY: GB |
| М | CONCR MASON | IRY – | | | | BOTTOM OF STRUCTURE | DATE: JUNE 7, 2023 PROJECT #: 1230236 |
| | UNIT (C | MU) W | WOOI | O STUD | В | 6" ABOVE CEILING | |
| G | METAL | STUD P | INSUL META | ATED | С | TO BOTTOM OF CEILING | SHEET TITLE |
| s | | NALL | | L L (IMP) | D | PARTIAL HEIGHT | PARTITION TYPES & APPLICABLE |
| Ľ | SHAFT | | | /IDTH | P | ARTITION TYPE MODIFIER | CODES |
| _ | | | IURE W | | | | |
| _ | RTITION METAL | WOOD | CMU | IMP | 1 | | |
| PA # 0 | ARTITION METAL *0-7/8" | | | IMP | | | |
| PA # 0 1 | ARTITION METAL *0-7/8" *1-1/2" | WOOD | | | 1 | | |
| P <i>A</i> # 0 1 2 | ARTITION METAL *0-7/8" *1-1/2" 2-1/2" | WOOD *1-1/2" | CMU | 2" | 2 | | |
| PA # 0 1 2 3 | RTITION METAL *0-7/8" *1-1/2" 2-1/2" 3-5/8" | WOOD *1-1/2" 2-1/2" | CMU | 2" 3" | | | |
| P <i>A</i> # 0 1 2 | ARTITION METAL *0-7/8" *1-1/2" 2-1/2" | WOOD *1-1/2" | CMU | 2" | 2 | | |
| PA # 0 1 2 3 4 | ARTITION METAL *0-7/8" *1-1/2" 2-1/2" 3-5/8" 4" | WOOD *1-1/2" 2-1/2" 3-1/2" | CMU 3-5/8" | 2" 3" 4" | 2 | | SHEET NUMBER |
| PA # 0 1 2 3 4 6 | ARTITION METAL *0-7/8" *1-1/2" 2-1/2" 3-5/8" 4" 6" | WOOD *1-1/2" 2-1/2" 3-1/2" | CMU 3-5/8" | 2" 3" 4" 6" | 2 | | SHEET NUMBER A-003 |
| PA # 0 1 2 3 4 6 7 | ARTITION METAL *0-7/8" *1-1/2" 2-1/2" 3-5/8" 4" 6" | WOOD *1-1/2" 2-1/2" 3-1/2" 5-1/2" | CMU 3-5/8" 5-5/8" | 2" 3" 4" 6" 7" | 2 3 4 | | |
| PA # 0 1 2 3 4 6 7 8 | ARTITION METAL *0-7/8" *1-1/2" 2-1/2" 3-5/8" 4" 6" 8" | WOOD *1-1/2" 2-1/2" 3-1/2" 5-1/2" 7-1/4" | CMU 3-5/8" 5-5/8" | 2" 3" 4" 6" 7" | 2 3 4 | * FURRING MEMBER | A-003 |
| PA # 0 1 2 3 4 6 7 8 10 | ARTITION METAL *0-7/8" *1-1/2" 2-1/2" 3-5/8" 4" 6" 8" 10" | WOOD *1-1/2" 2-1/2" 3-1/2" 5-1/2" 7-1/4" 9-1/4" | CMU 3-5/8" 5-5/8" 7-5/8" | 2" 3" 4" 6" 7" 8" | 2 3 4 | * FURRING MEMBER | |

5

PARTITION TYPES DESCRIBE GENERAL REQUIREMENTS


FOR PARTITIONS. REFER TO THE MANUFACTURER'S

INTERIOR PARTITION GENERAL NOTES


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1301 Gervais Street,

Suite 1300



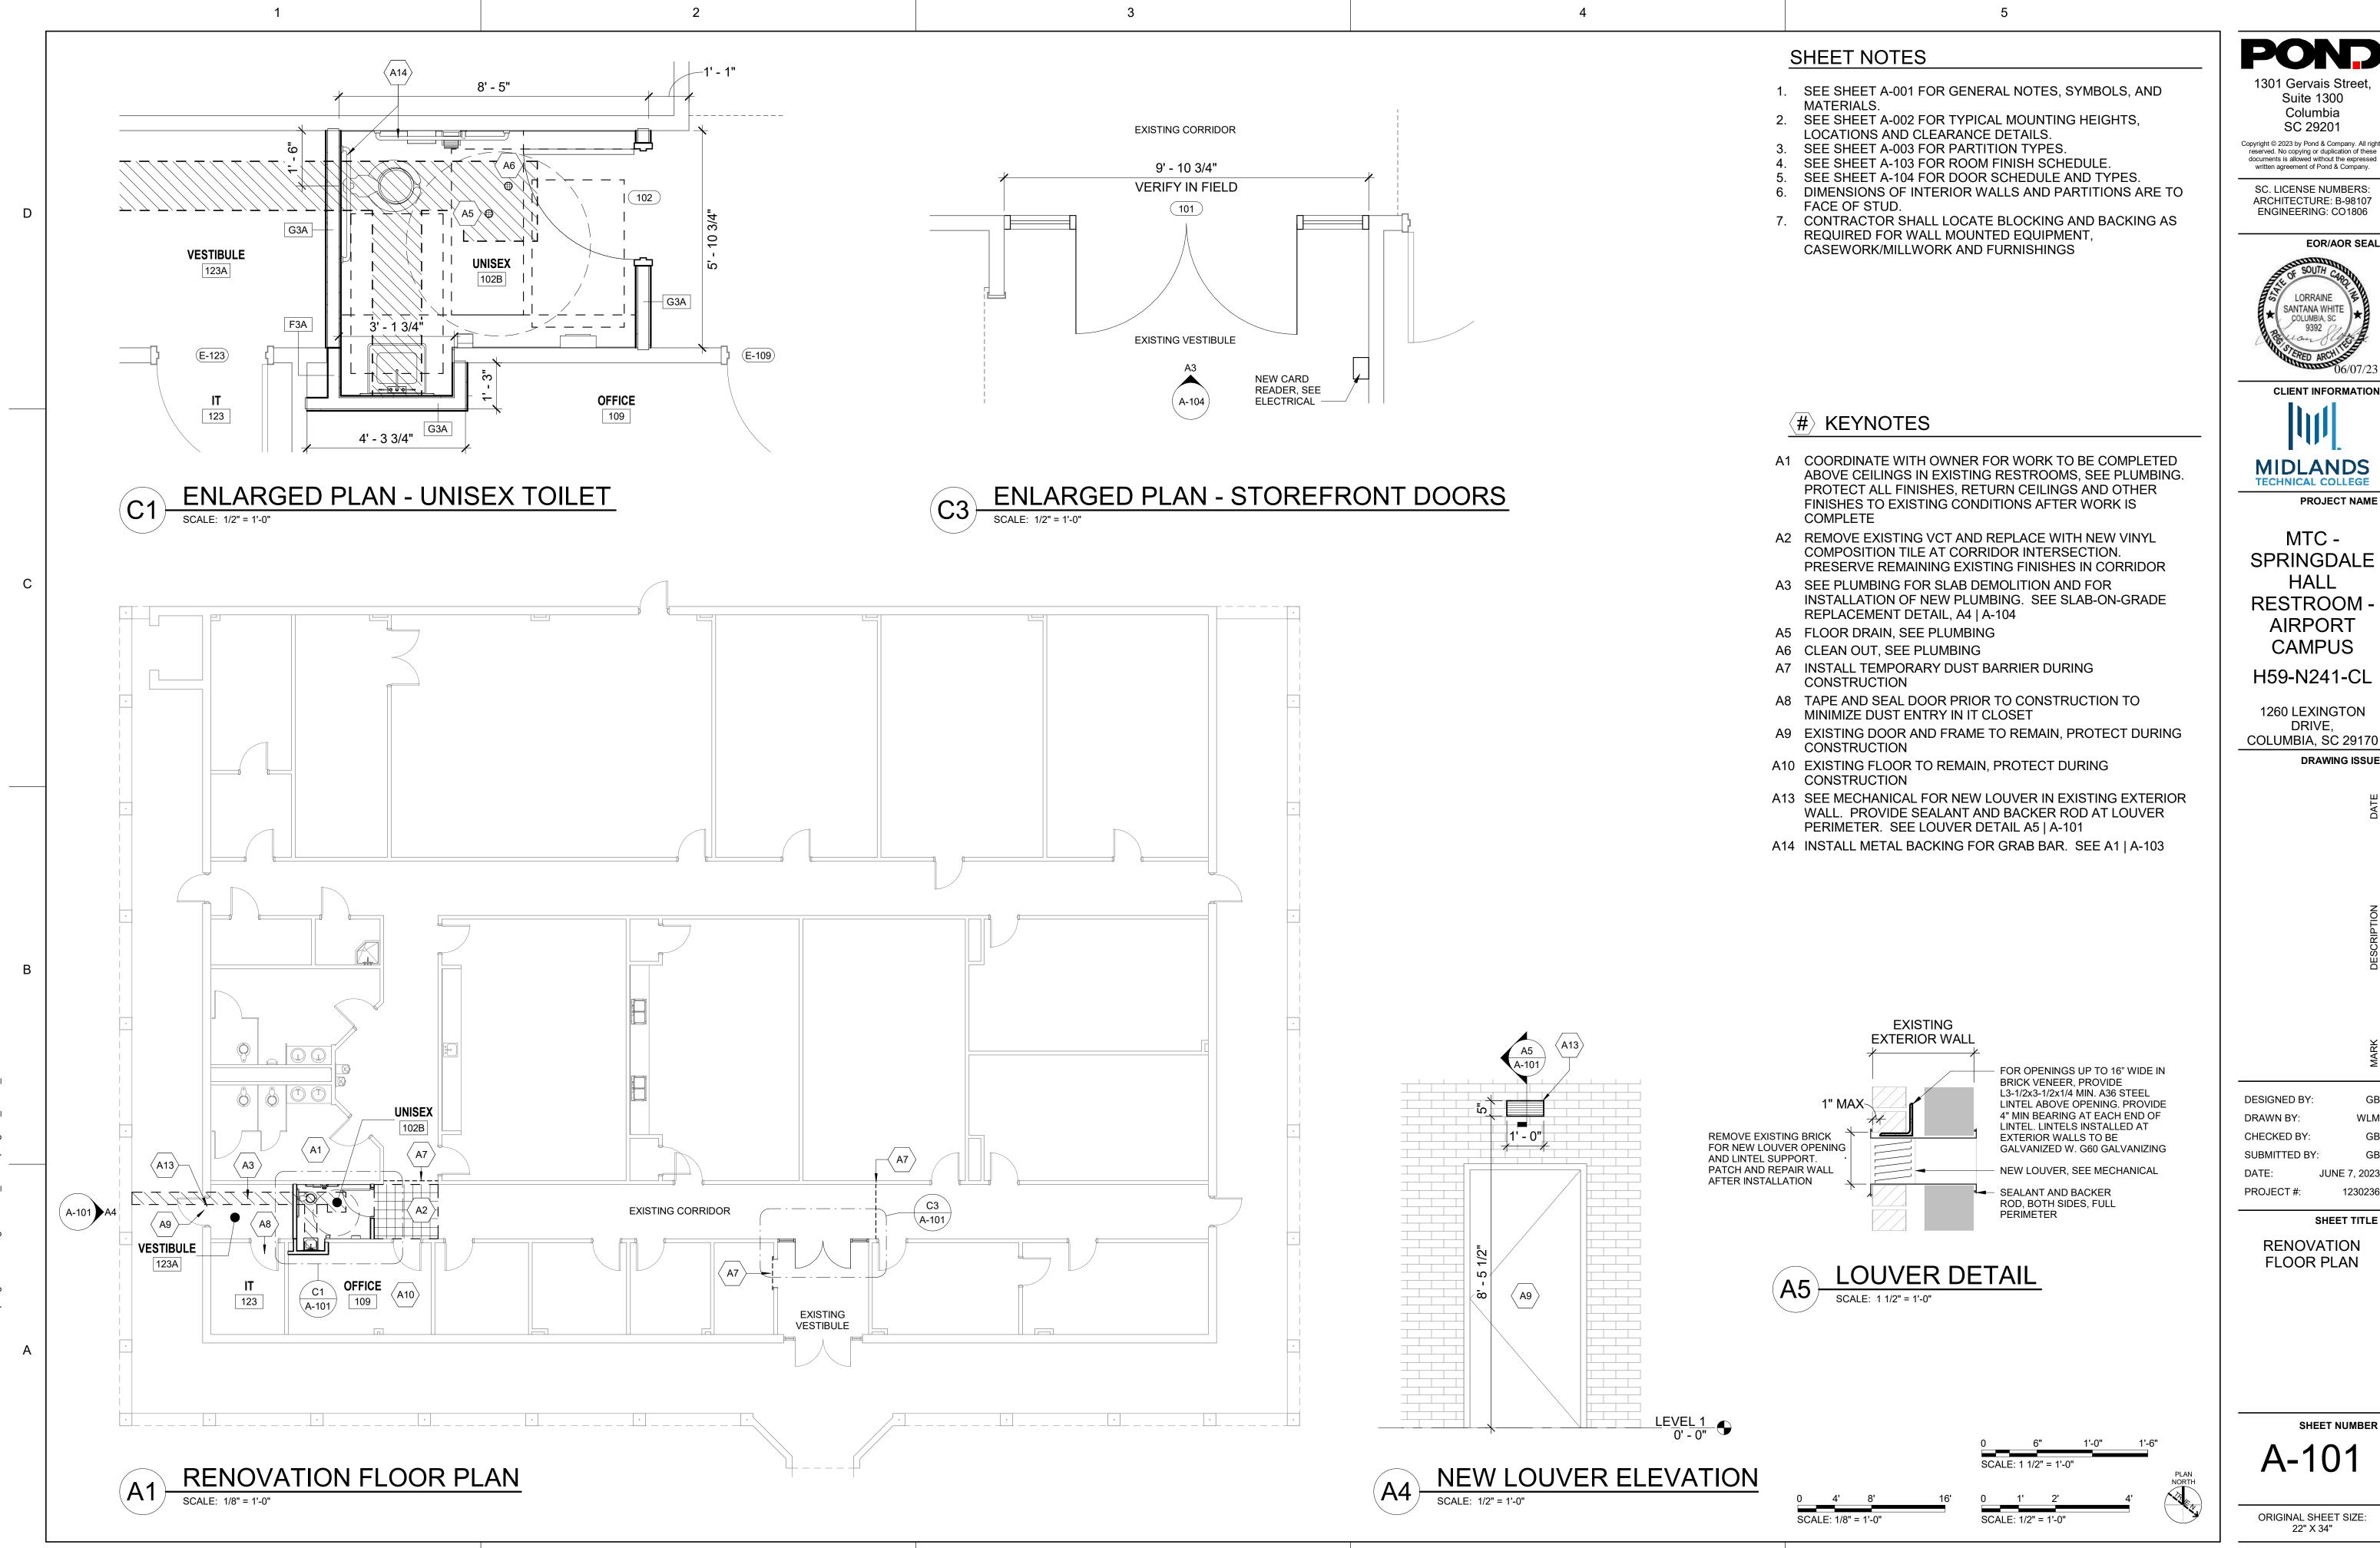





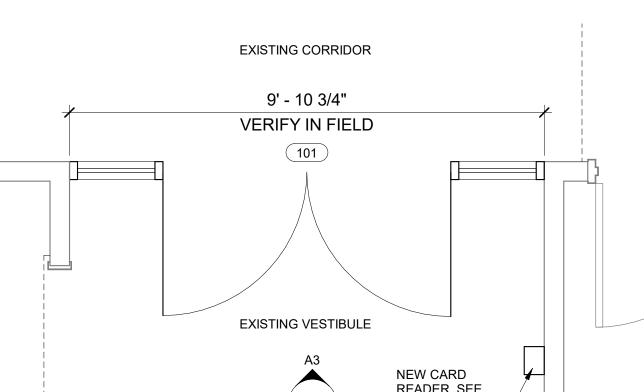

1301 Gervais Street Copyright © 2023 by Pond & Company. All rights reserved. No copying or duplication of these documents is allowed without the expressed written agreement of Pond & Company. SC. LICENSE NUMBERS: ARCHITECTURE: B-98107 ENGINEERING: CO1806 EOR/AOR SEAL **CLIENT INFORMATION MIDLANDS TECHNICAL COLLEGE** PROJECT NAME SPRINGDALE **RESTROOM -**AIRPORT CAMPUS H59-N241-CL 1260 LEXINGTON COLUMBIA, SC 29170 DRAWING ISSUE JUNE 7, 2023 1230236 SHEET TITLE RENOVATION

CONSRUCTION DOCUMENTS

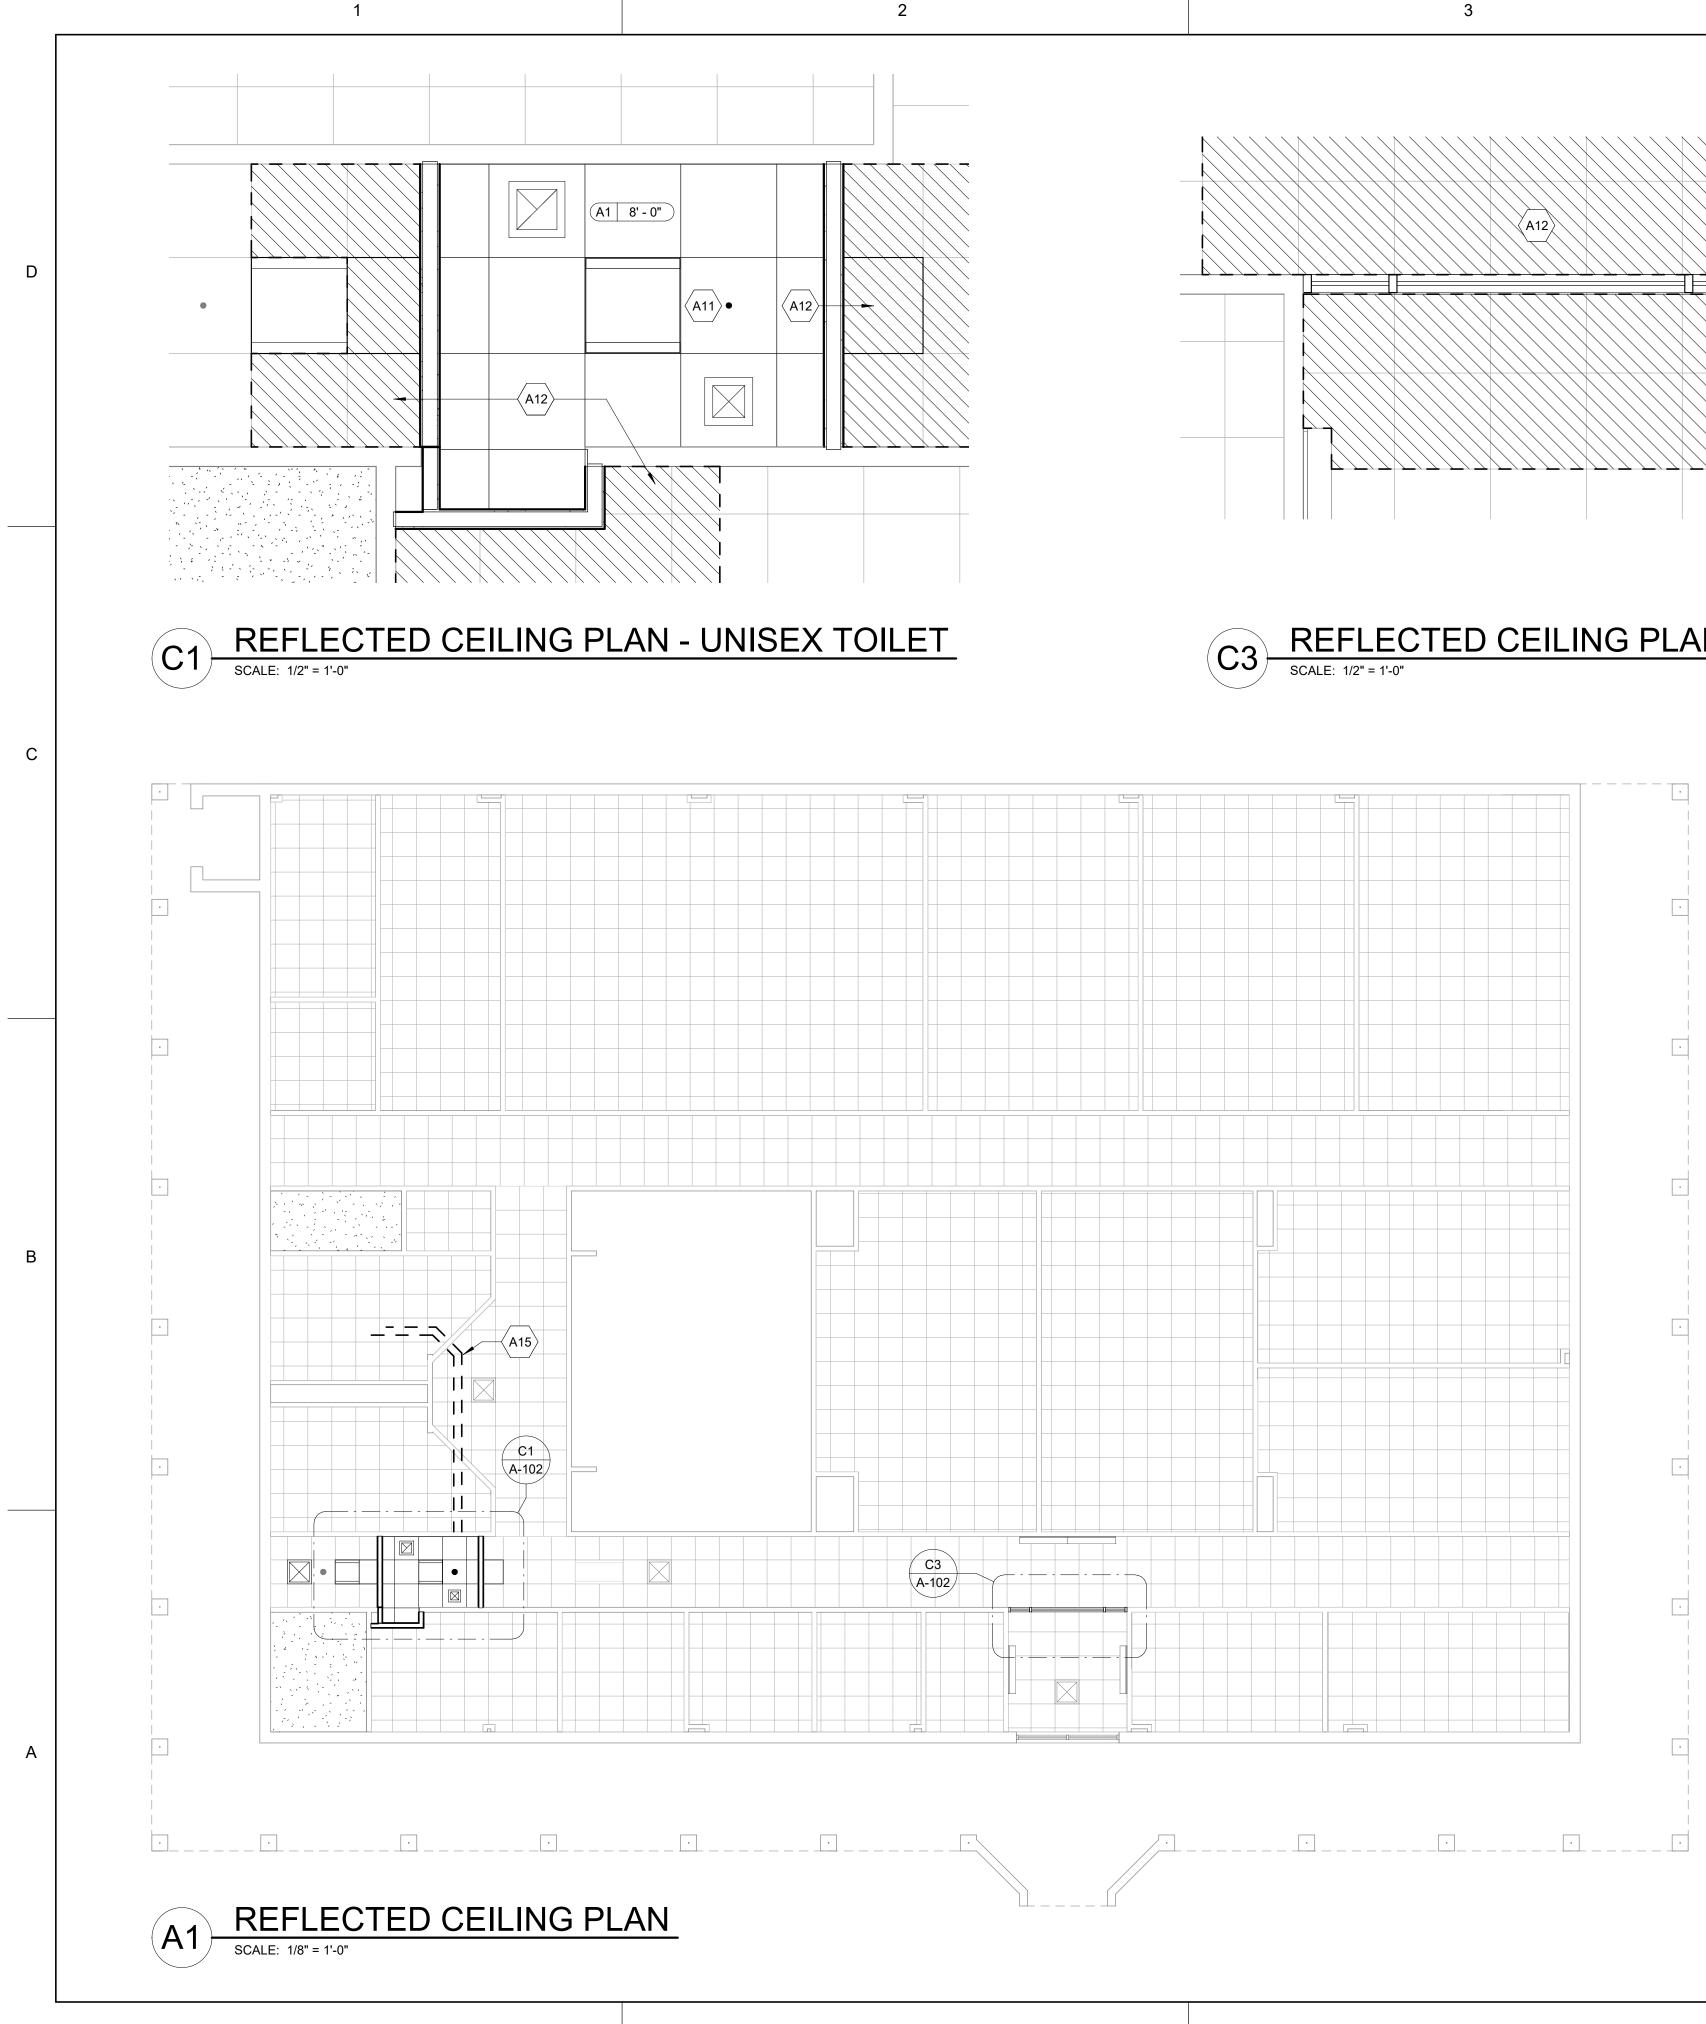

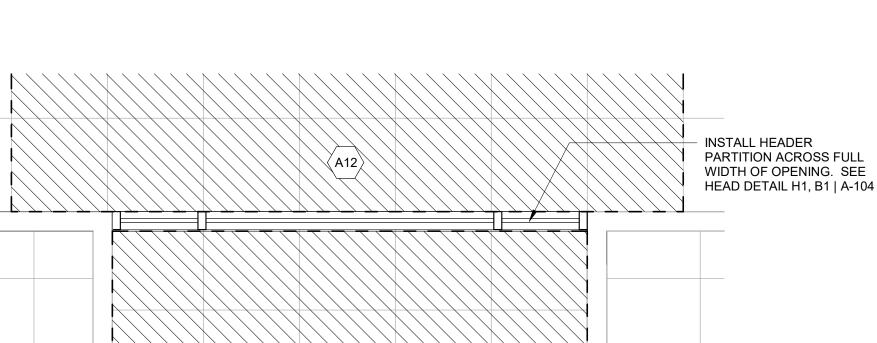

REFLECTED CEILING PLAN - STOREFRONT DOORS

4

5

SHEET NOTES

- ALL CEILING MOUNTED DEVICES SHALL BE CENTERED IN BOTH DIRECTIONS IN ACOUSTICAL CEILING PANELS U.N.O. CENTER SPRINKLER HEADS IN ACOUST. CEILING PANELS WHERE THEY OCCUR - COORDINATE THE LOCATION OF THE SPRINKLER HEADS WITH OTHER CEILING FIXTURES AND EQUIPMENT IN ALL CEILING. ENSURE THAT A SYMMETRICAL AND BALANCED ARRANGEMENT IS INSTALLED.
- CEILING HEIGHTS INDICATED (I.E. 9'-0") ARE RELATIVE TO 2 THE FINISH FLOOR ELEVATION OF THE ROOM FOR WHICH THEY ARE INDICATED.
- 3. CEILING GRIDS SHALL BE ORIENTED WITHIN SPACES AS SHOWN, U.N.O. FULL TILE (FT) WHERE INDICATED, SHALL ABUT DESIGNATED WALL. LIMIT PARTIAL PANELS TO NO LESS THAN 6".
- 4. DEVICES HAVE BEEN SHOWN FOR COORDINATION PURPOSES. ALL DEVICES MAY NOT BE SHOWN.
- 5. THE CONTRACTOR SHALL ENSURE THE INSTALLATION OF ALL DEVICES INDICATED ON THE ENGR. DWG. SEE MECHANICAL, ELECTRICAL, PLUMBING AND FIRE PROTECTION DRAWINGS FOR ITEMS NOT SHOWN ON REFLECTED CEILING PLANS. CONTACT THE ARCHITECT IF ANY CONFLICTS OCCUR.
- 6. AT WALLS WITH SOUND ATTENUATION BLANKETS PROVIDE SOUND ATTENUATION BLANKETS ON CEILING TO 2'-0" ON BOTH SIDES OF WALL EXCEPT AT WALLS WITH SOUND ATTENUATION BLANKETS EXTENDING TO STRUCTURE.

(#) KEYNOTES

- A11 ADJUST SPRINKLER HEAD TO NEW LOCATION, SEE FIRE PROTECTION DRAWINGS, SP1
- A12 REMOVE PORTION OF EXISTING CEILING PANELS AND SUSPENSION GRID TO CEILING GRID MEMBER INDICATED TO CONSTRUCT NEW PARTITIONS, REINSTALL ONCE COMPLETE
- A15 SEE PLUMBING FOR ABOVE CEILING PIPE WORK

LEGEND

 \bowtie

2' X 4' LAY-IN LIGHT FIXTURE

2' X 2' LAY-IN LIGHT FIXTURE

SUPPLY AIR DEVICE

EXHAUST AIR DEVICE

A1

5/8" GYPSUM BOARD

2'-0" x 2'-0" ACOUSTICAL CEILING SYSTEM

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POND

1301 Gervais Street

H59-N241-CL

1260 LEXINGTON DRIVE, COLUMBIA, SC 29170 DRAWING ISSUE

| GB |
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| WLM |
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| C: GB |
| JUNE 7, 2023 |
| 1230236 |
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SHEET TITLE


REFLECTED **CEILING PLAN**


SHEET NUMBER A-102 ORIGINAL SHEET SIZE: 22" X 34"

CONSRUCTION DOCUMENTS

SCALE: 1/8" = 1'-0"

SCALE: 1/2" = 1'-0"

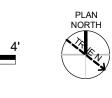

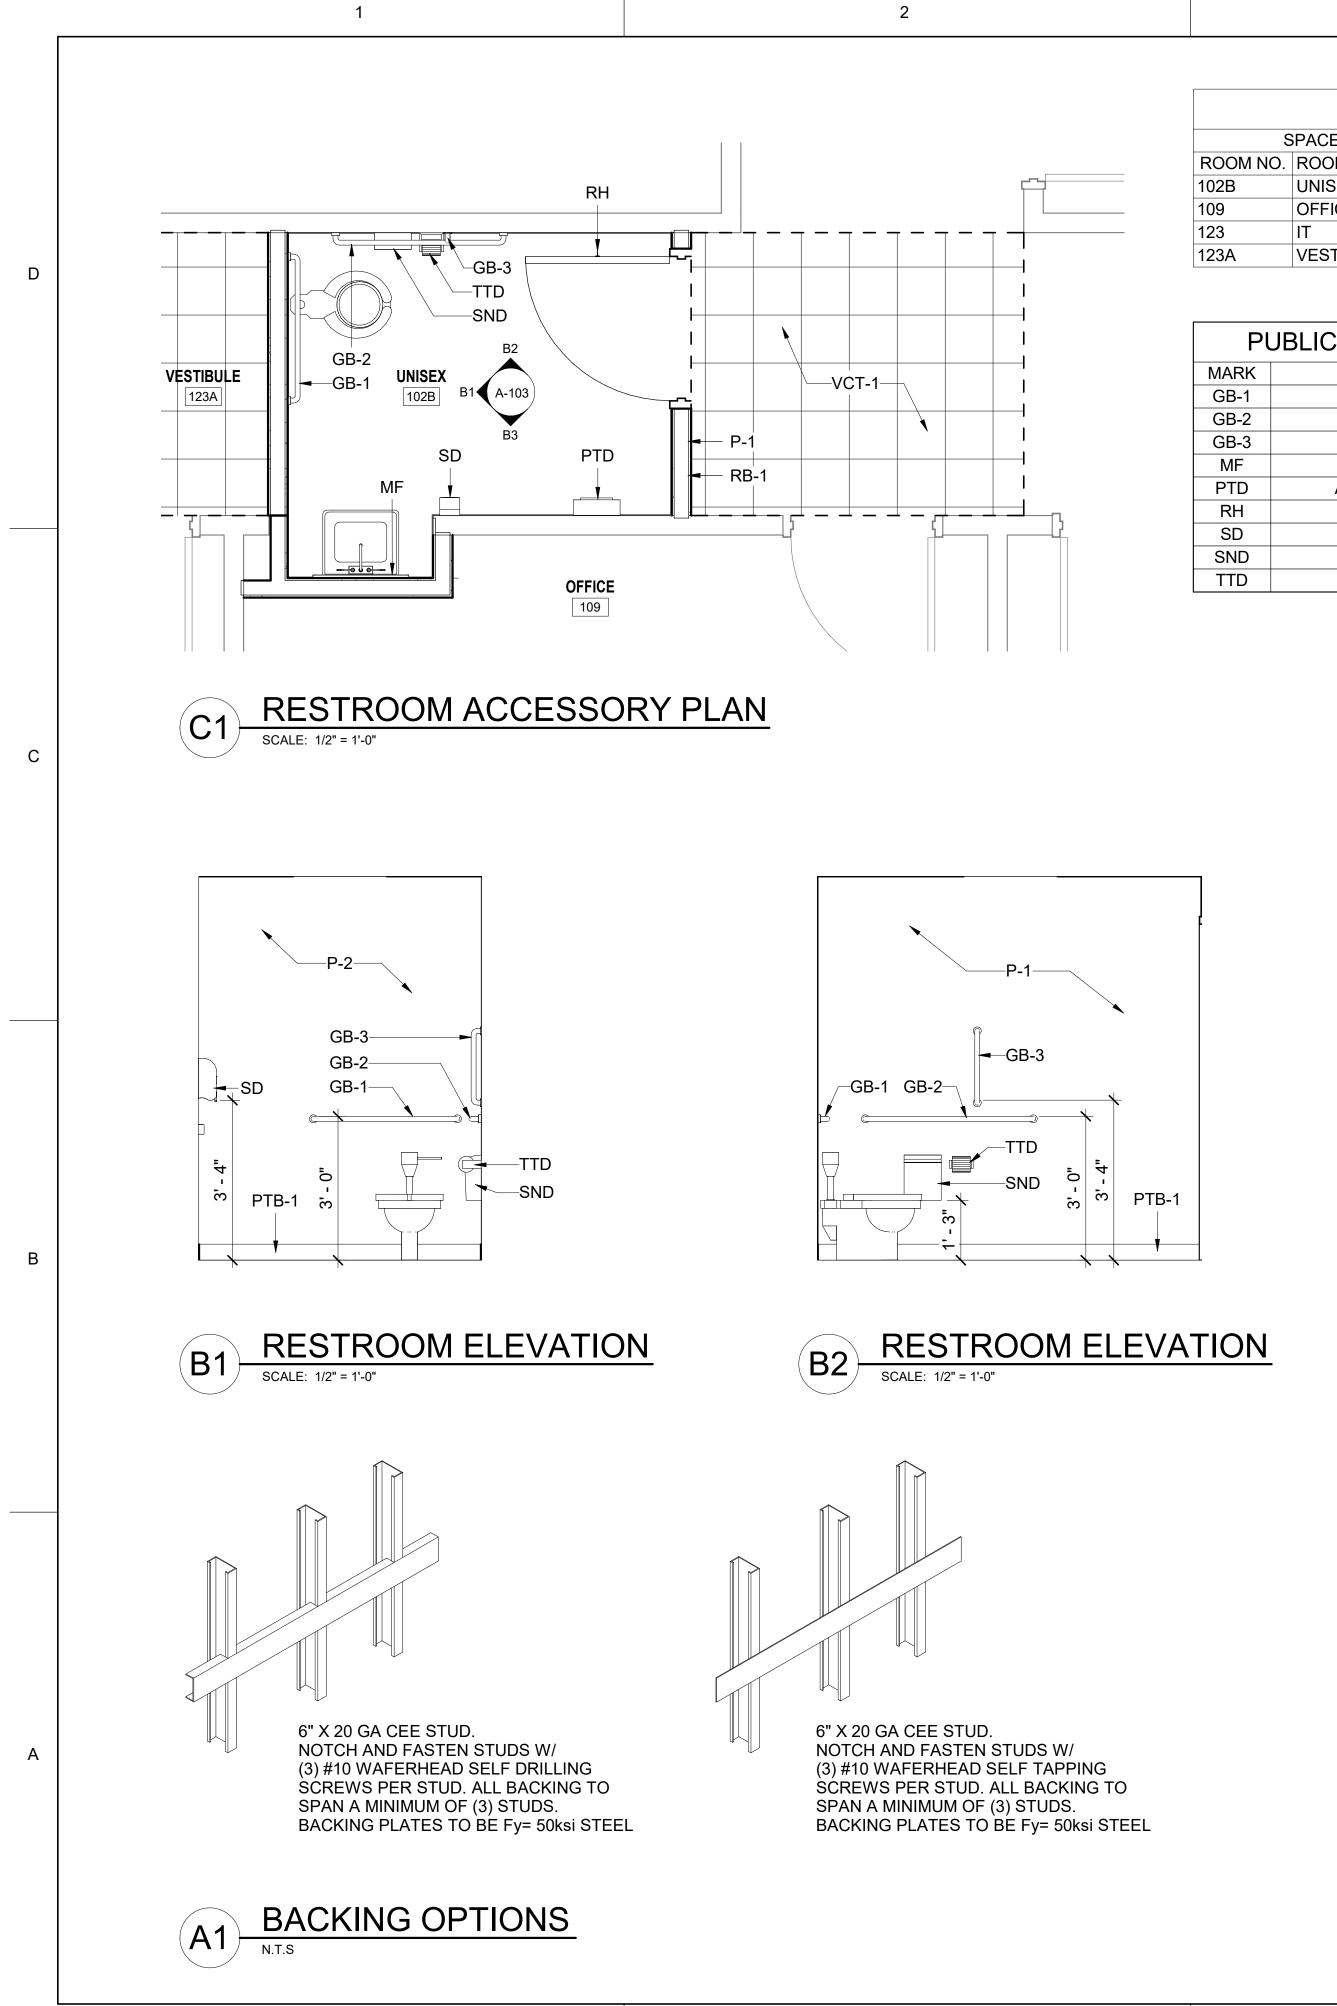


| FINISH SCHEDULE | | | | | | | | |
|---------------------------|-----------|----------|-------|-------|------|---------|------|----------|
| SPACE FLOOR WALLS CEILING | | | | | | | | CEILING |
| ROOM NO. | ROOM NAME | MAT. | BASE | NORTH | EAST | SOUTH | WEST | FIN. |
| 102B | UNISEX | PT-1 | PTB-1 | P-1 | P-1 | P-1/P-2 | P-2 | ACT-1 |
| 109 | OFFICE | EXISTING | RB-1 | P-1 | P-1 | P-1 | P-1 | EXISTING |
| 123 | IT | - | - | - | - | - | - | - |
| 123A | VESTIBULE | VCT-1 | RB-1 | P-1 | P-1 | P-1 | P-1 | ACT-1 |

| PUBLIC RESTROOM ACCESSORIES | | | | | | |
|-----------------------------|----------------------------------|--|--|--|--|--|
| MARK | DESCRIPTION | | | | | |
| GB-1 | 36" GRAB BAR | | | | | |
| GB-2 | 42" GRAB BAR | | | | | |
| GB-3 | 18" GRAB BAR | | | | | |
| MF | MIRROR - FRAMED | | | | | |
| PTD | ACCESSIBLE PAPER TOWEL DISPENSER | | | | | |
| RH | ROBE HOOK | | | | | |
| SD | SOAP DISPENSER | | | | | |
| SND | SANITARY NAPKIN DISPOSAL | | | | | |
| TTD | TOILET PAPER DISPENSER | | | | | |
| | | | | | | |

FINISH LEGEND <u>CEILING</u> ACT-1 <u>WALLS</u> P-1 P-2 <u>FLOORS</u> PT-1 PTB-1 VCT-1 RB-1

4

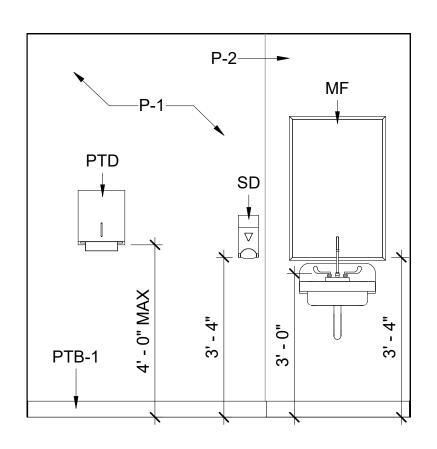

RESTROOM ELEVATION SCALE: 1/2" = 1'-0" (B3)

ACOUSTICAL CEILING TILE: ARMSTRONG CEILING, DUNE 1850, SIZE: 24" X 24", SQUARE LAY-IN 15/16", WHITE

PAINT: SHERWIN WILLIAMS, EPOXY PAINT, EIDER WHITE SW7014, SATIN FINISH

PAINT: SHERWIN WILLIAMS, EPOXY PAINT, GOSSAMER VEIL SW9165, SATIN FINSIH


PORCELAIN TILE: DALTILE, LINDEN POINT LP21, GRIGIO 12X24 PORCELAIN TILE BASE: DALTILE, LINDEN POINT LP21, GRIGIO, BULLNOSE 3X12, P43C9

VINYL COMPOSITION TILE: AZROCK COLLECTION, #V-223 STONE NEUTRAL, 12X12

RUBBER BASE: JOHNSONITE, COVE BASE, 4", MEDIUM GRAY 28

| PON | |
|--|---|
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| Suite 1300 Columbia SC 29201 | - |
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| SANTANA WHIT COLUMBIA, SC 9392 | |
| STERED ARCHI | 6/07/23 |
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| MIDLAN TECHNICAL COL | |
| PROJEC | TNAME |
| - MTC SPRINGD | |
| HALL | |
| RESTROC AIRPOF | |
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| H59-N241 | |
| 1260 LEXING DRIVE, COLUMBIA, SC | |
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| CHECKED BY: SUBMITTED BY: | GB GB |
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| INTERIOI FINISHE | - |
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| | |
| SHEET N | UMBER |
| A-10 | 3 |
| | |
| ORIGINAL SHEET 22" X 34" | SIZE: |

SCALE: 1/2" = 1'-0"

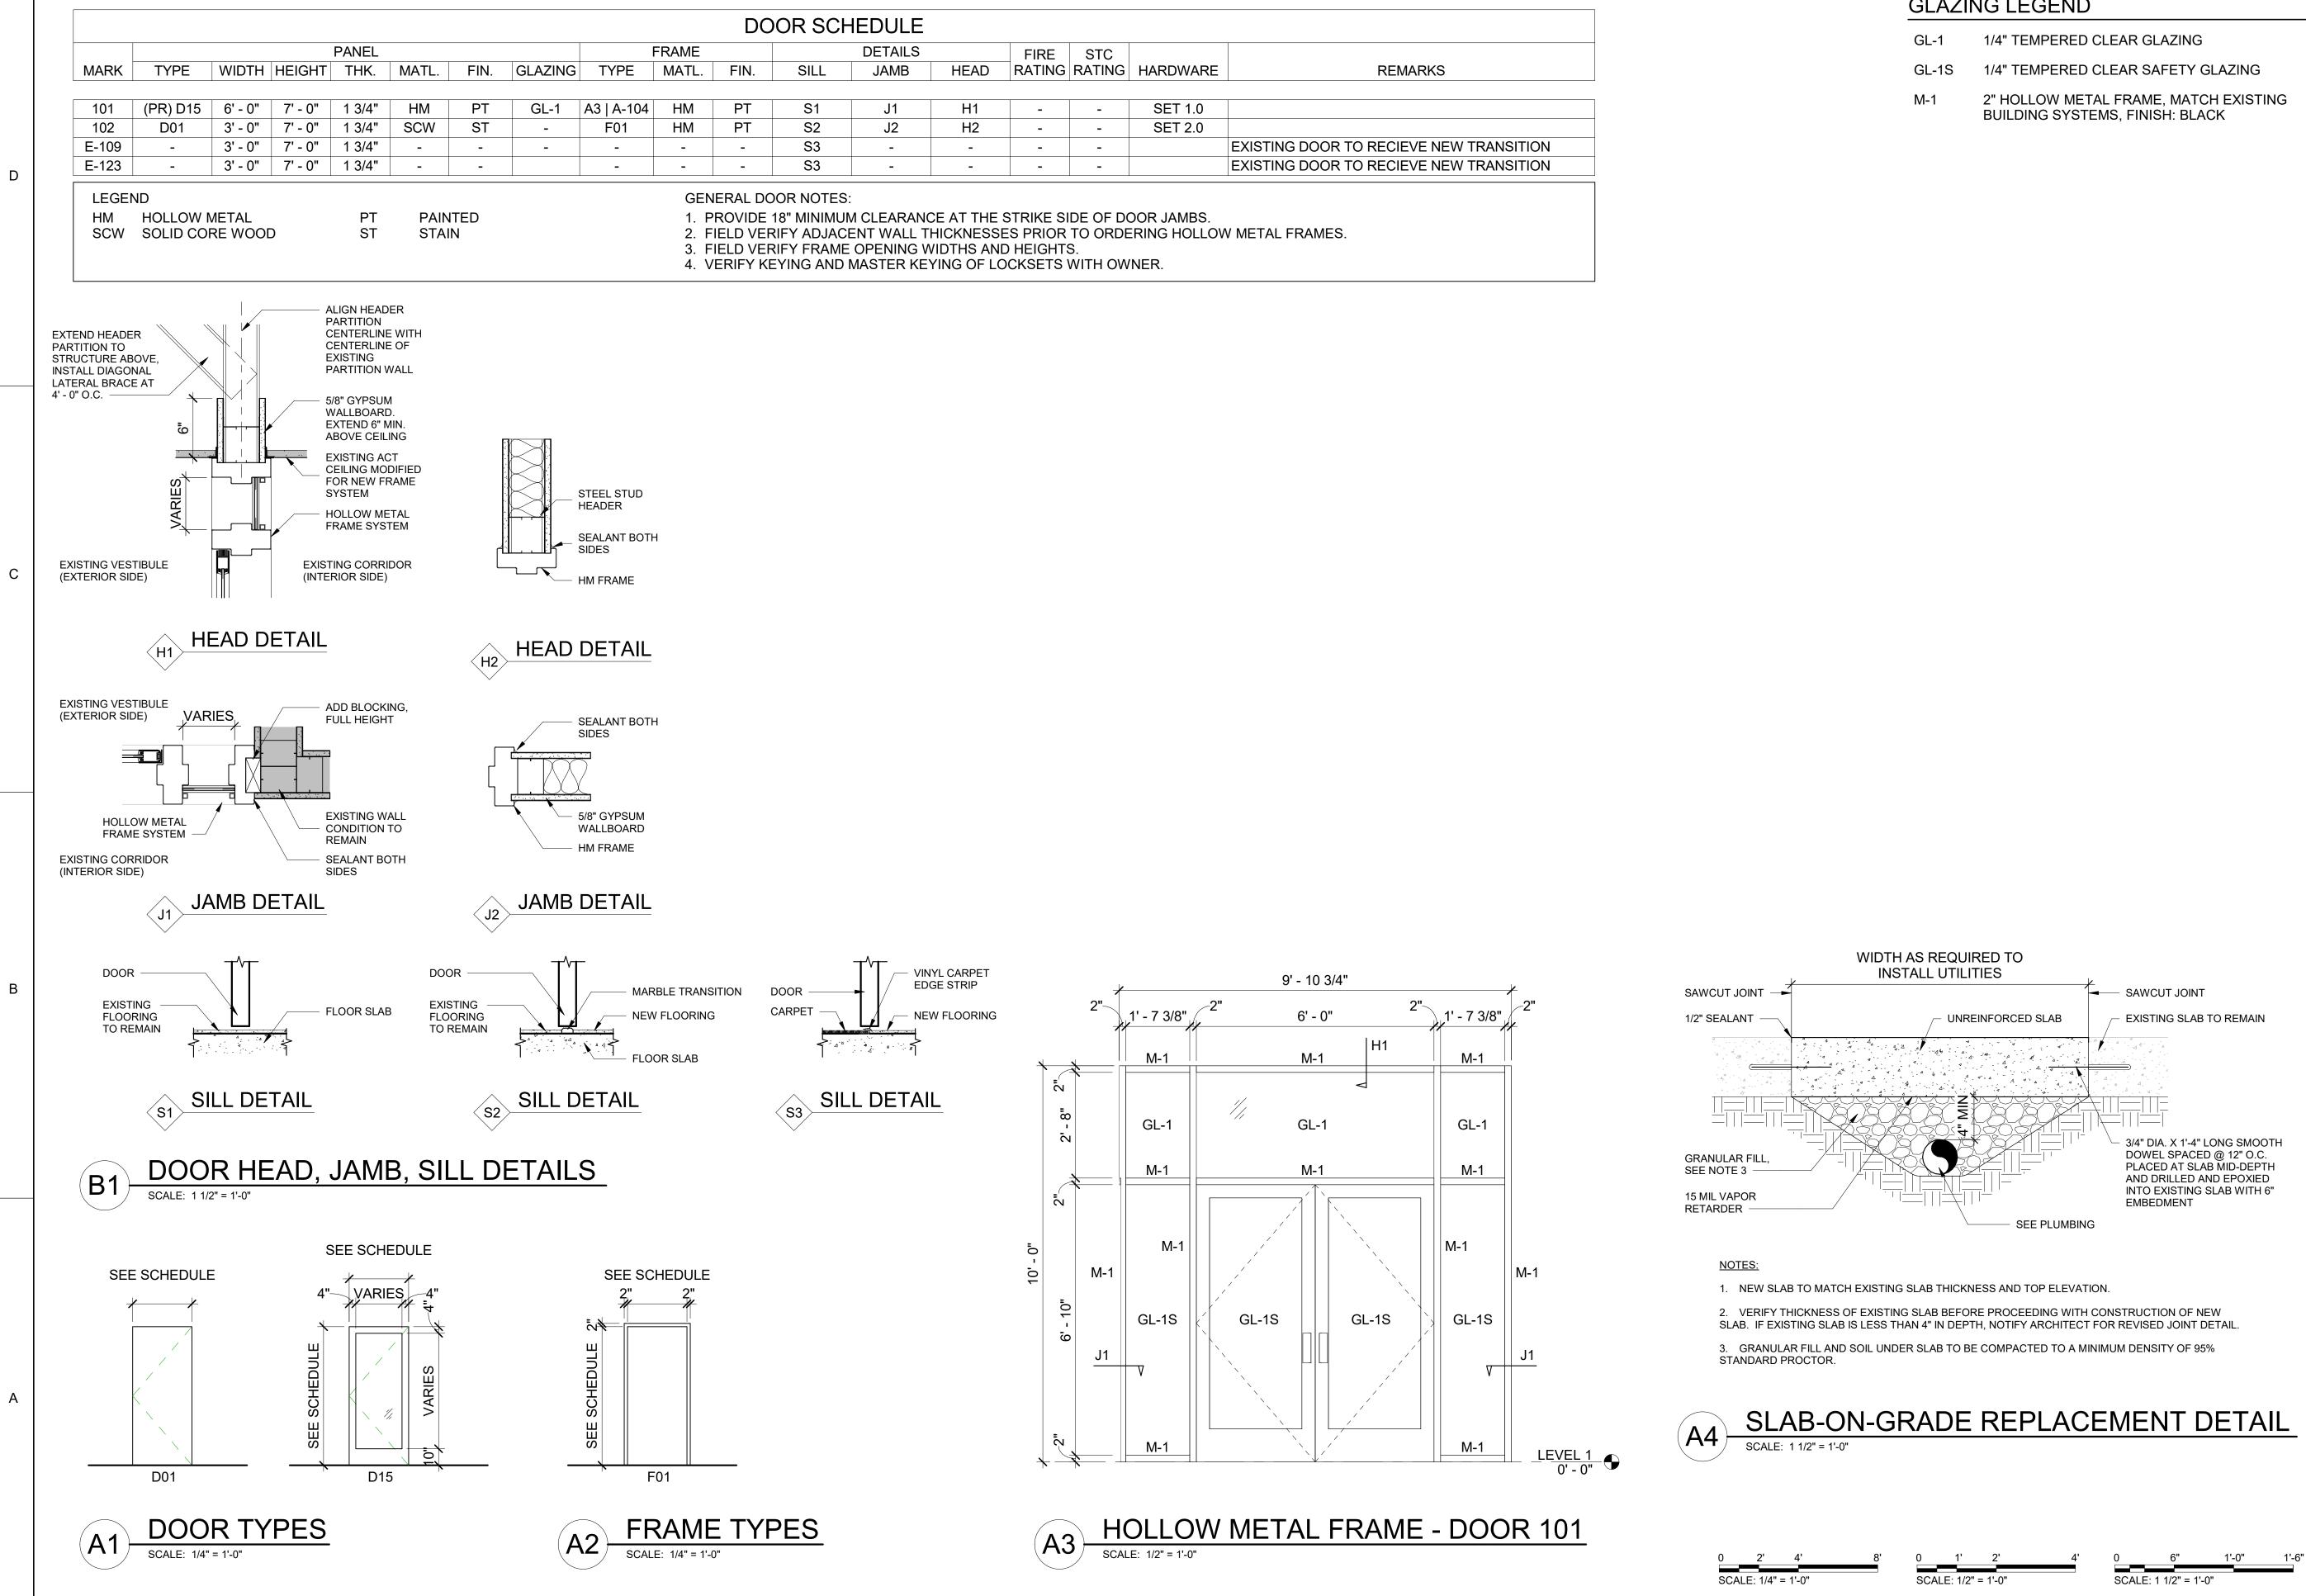



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| JLE | | | | | |
|------|------|--------|--------|----------|---|
| AILS | | FIRE | STC | | |
| ИВ | HEAD | RATING | RATING | HARDWARE | REMARKS |
| | | | | | |
| 1 | H1 | - | - | SET 1.0 | |
| 2 | H2 | - | - | SET 2.0 | |
| | - | - | - | | EXISTING DOOR TO RECIEVE NEW TRANSITION |
| | - | - | - | | EXISTING DOOR TO RECIEVE NEW TRANSITION |
| | | | | | |

GLAZING LEGEND

| GL-1 | 1/4" TEMPERED CLEAR GLAZING |
|-------|-------------------------------------|
| GL-1S | 1/4" TEMPERED CLEAR SAFETY GLAZING |
| M-1 | 2" HOLLOW METAL FRAME. MATCH EXISTI |




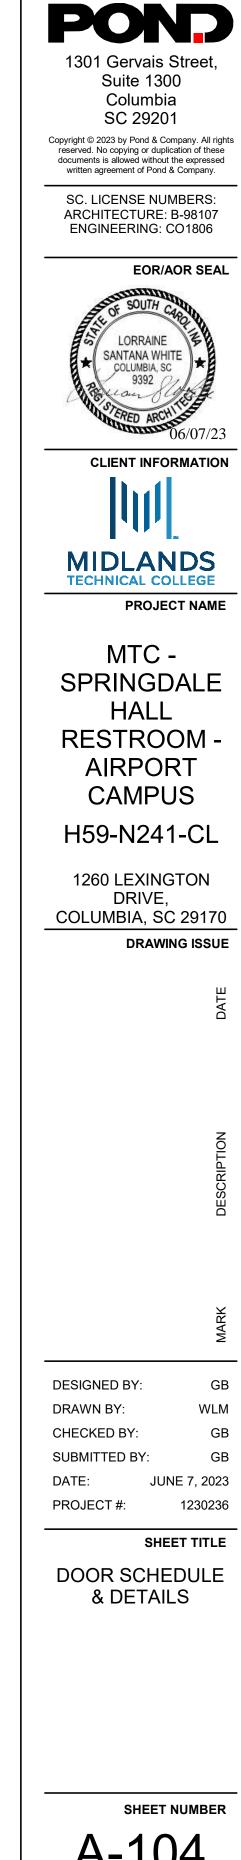

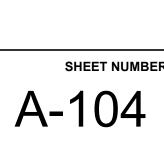ORIGINAL SHEET SIZE:


22" X 34"

CONSRUCTION DOCUMENTS

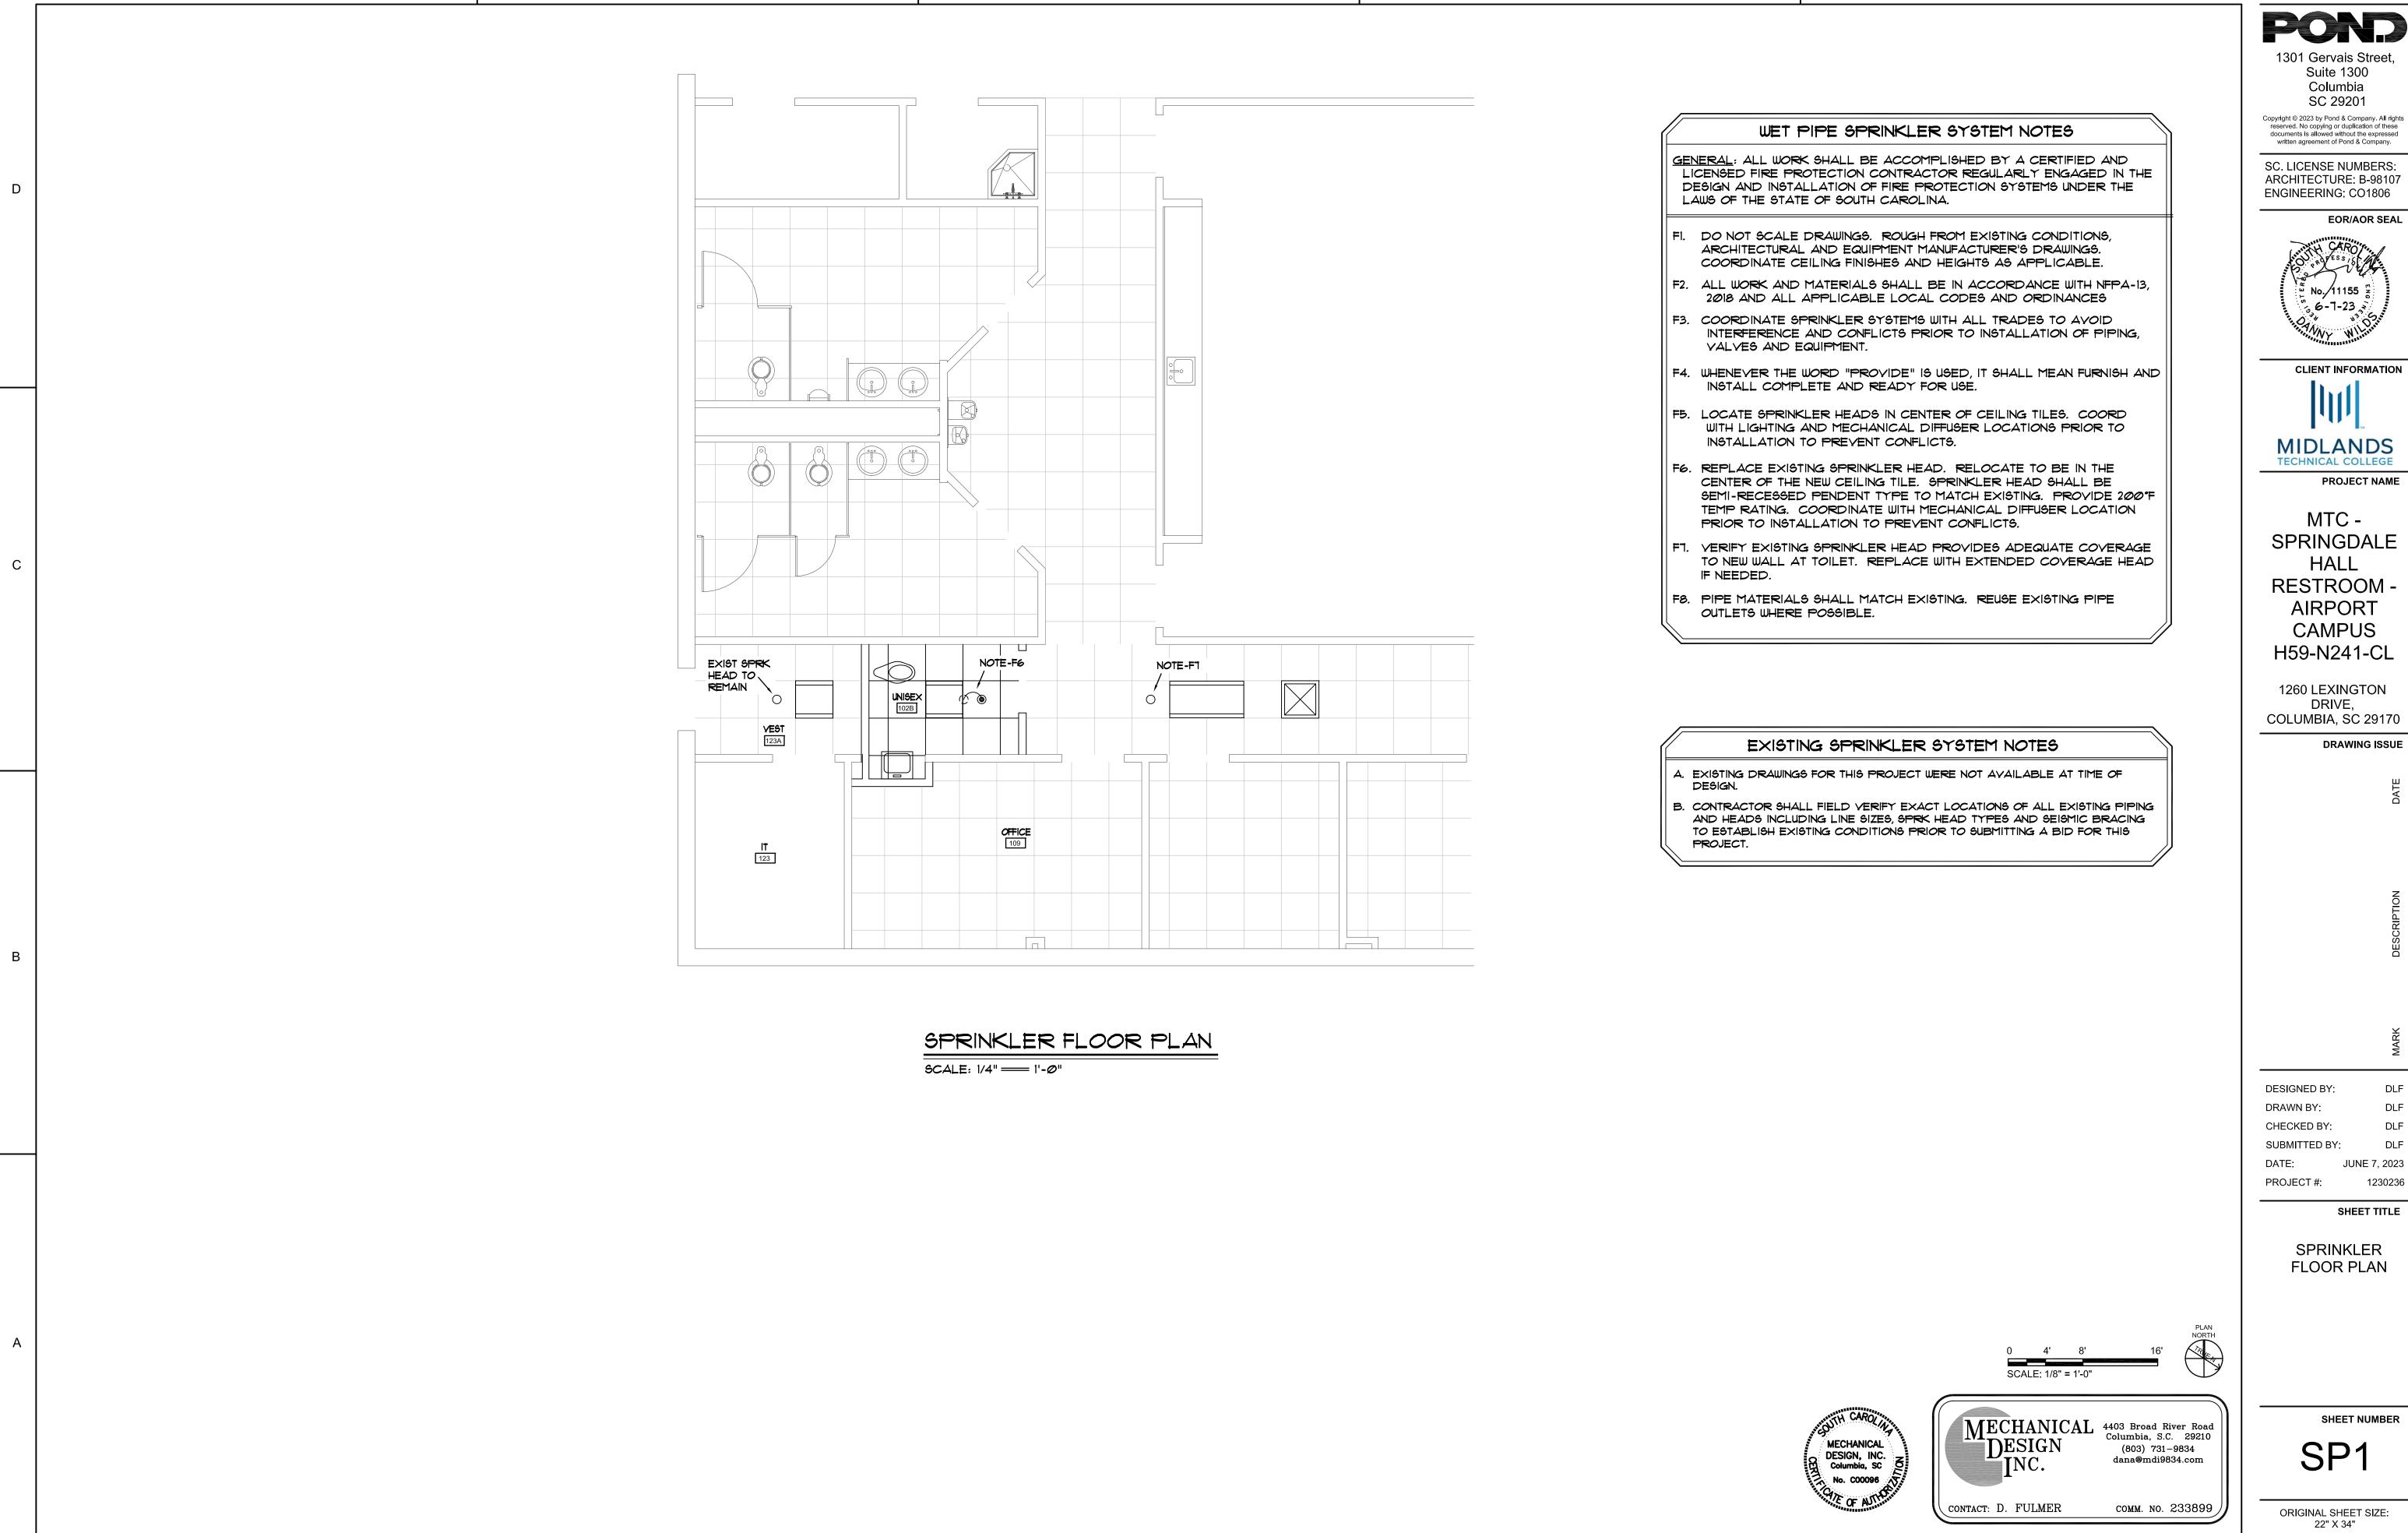


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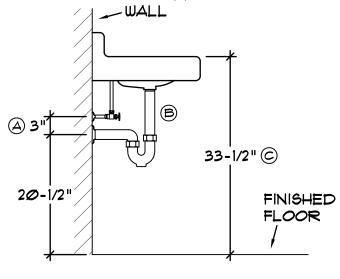
CONSTRUCTION DOCUMENTS

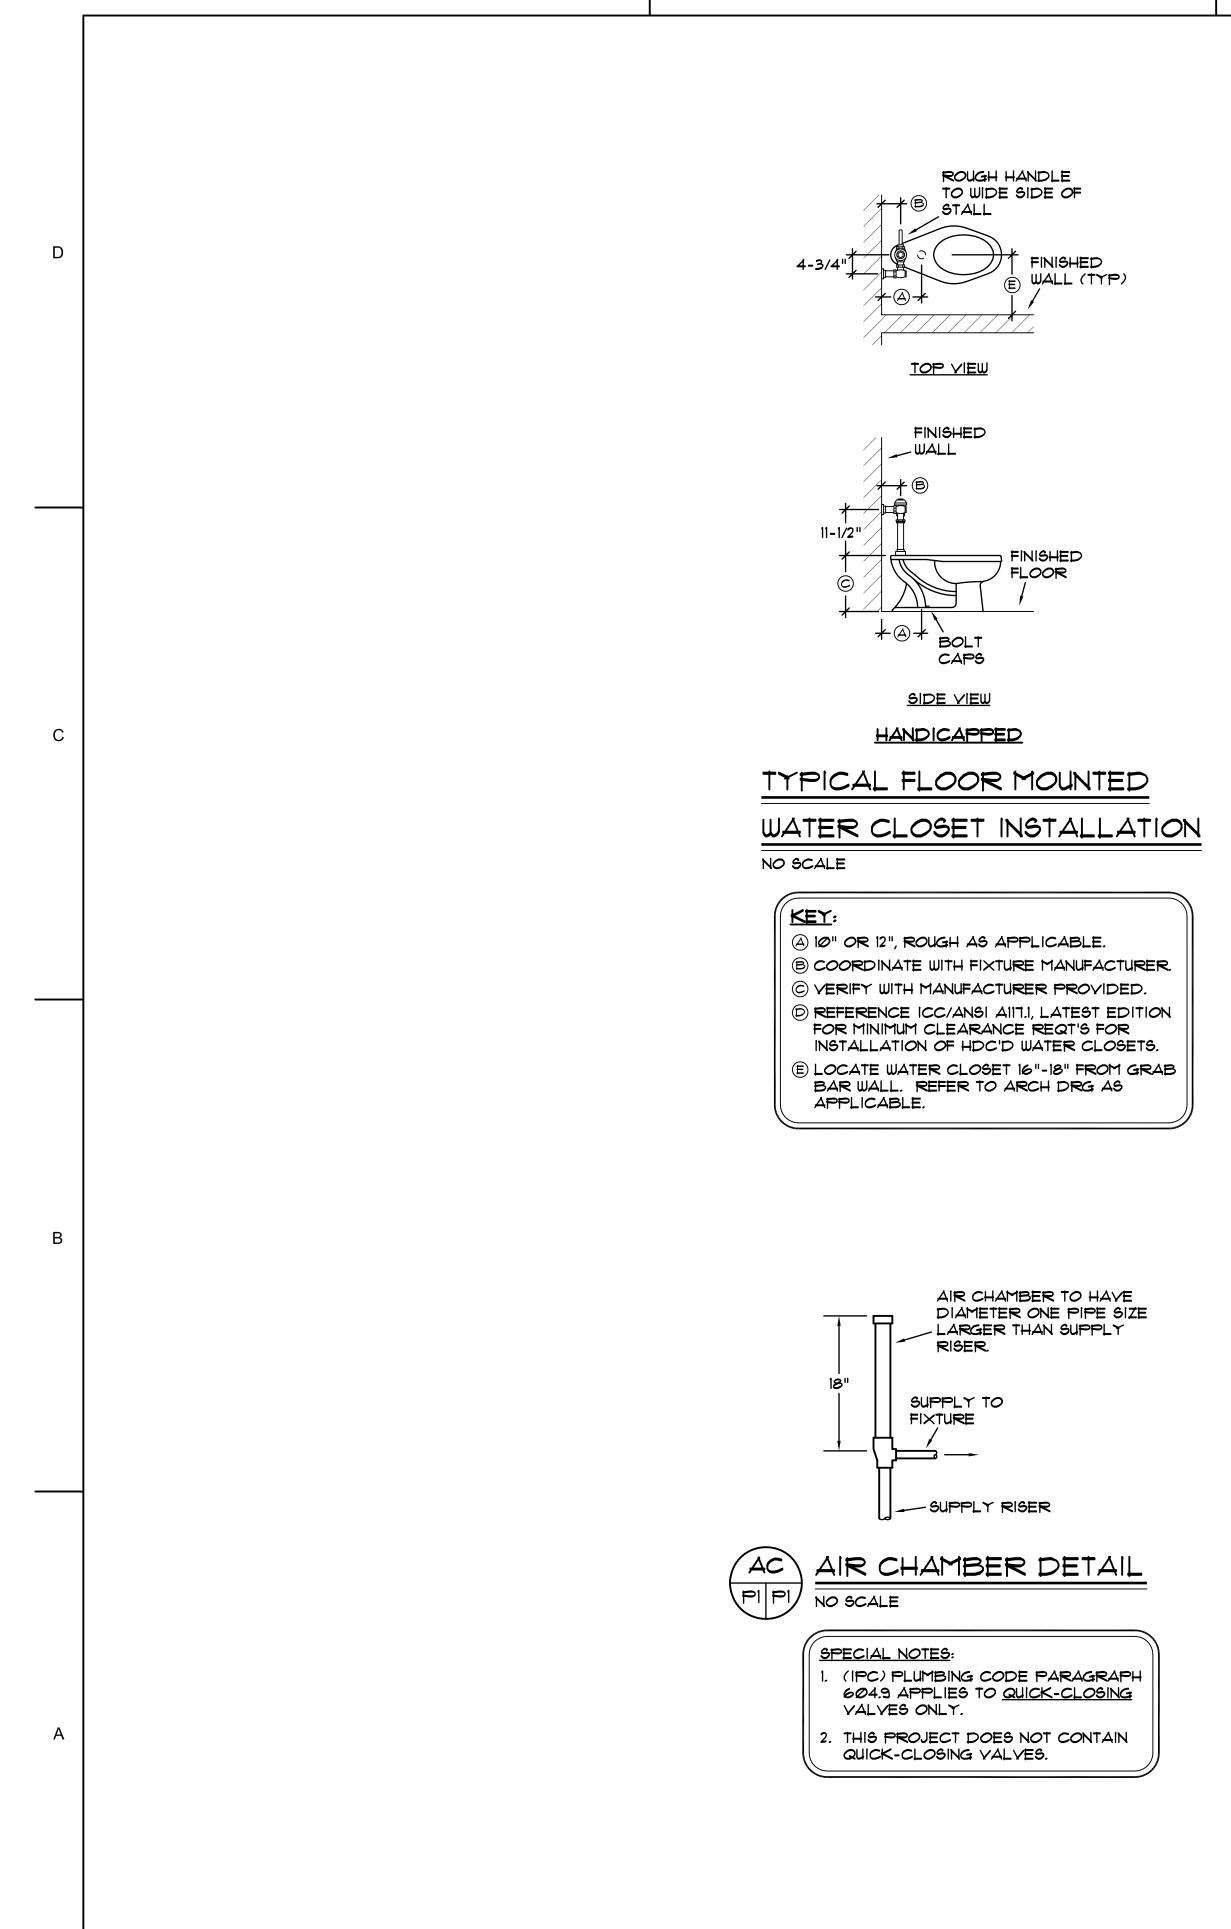

4





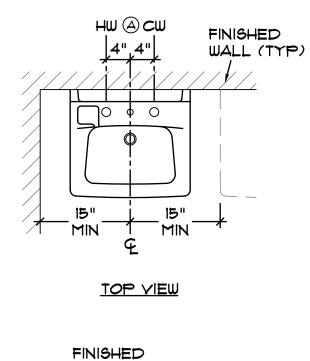








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<u>Key</u>:


(A) COORDINATE AND MAINTAIN ROUGH-IN DIMENSIONS FOR SUPPLIES AND WASTE OUTLET AS INDICATED. (SEE SPECIFICATIONS) <u>SUPPLIES SHALL BE</u> LOCATED 3" ABOVE WASTE OUTLET AS SHOWN.

(B) CONTRACTOR SHALL ORDER TAILPIECE LENGTH FOR FIXTURE AS REQUIRED.

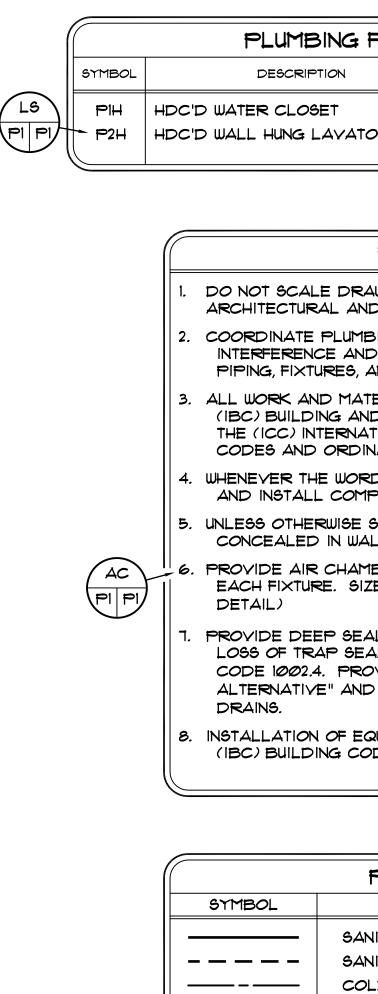


_____ ⊖ **FCO** Ø FD1 CW, HW

HDC'D

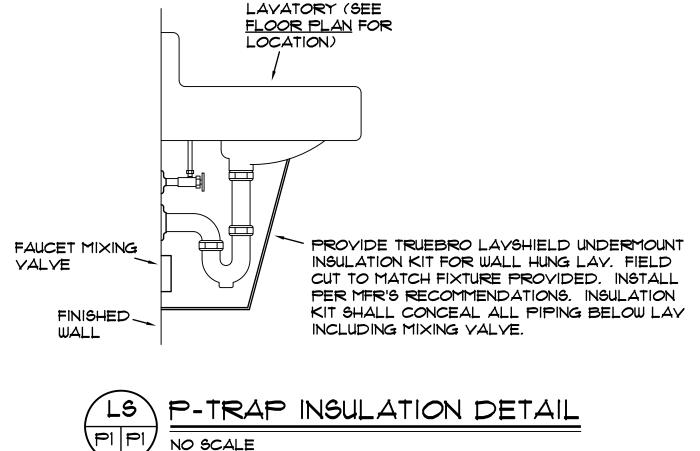

NO SCALE



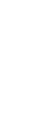

WITH CAROLIA

MECHANICAL

DESIGN, INC. Columbia, SC

No. C00096

THE OF AN

| | | | | | | | | PORD 1301 Gervais Street, Suite 1300 Columbia |
|---|-------------------------------|---------------------------------------|--|---------------------------------------|-----------------------------------|--|---------------|---|
| NG FIXTURE | SCH | EDUL | .E | | | | | SC 29201 Copyright © 2023 by Pond & Company. All rights |
| ON | CW | ΗW | WASTE | VENT | MOUNTING HEIGHT | | | reserved. No copying or duplication of these documents is allowed without the expressed written agreement of Pond & Company. |
| T AVATORY | 1" 1/2" | 1/2" | 2" 2" | 1-1/2" 1-1/2" | 16-5/8" 33-1/2" |) | | SC. LICENSE NUMBERS: ARCHITECTURE: B-98107 ENGINEERING: CO1806 |
| PLUMBI | | | | | | | | EOR/AOR SEAL |
| E DRAWINGS. RC L AND EQUIPME PLUMBING SYSTE E AND CONFLICT | DUGH FF NT MAN MS WIT | ROM EX NUFACT H ALL | URER'S I TRADES | RAWIN TO AV | igs. OID | | | E No. 11155 E 6-7-23 - |
| PRES, AND EQUIPT MATERIALS SH G AND (IPC) PL ERNATIONAL CO ORDINANCES. | MENT. ALL BI UMBINC | E IN AC 5 CODE | CORDA1 ES, 2021 E | NCE WI | TH THE NG <i>O</i> F | | | |
| WORD "PROVID COMPLETE AND | READ | T FOR | USE. | | | | | MIDLANDS TECHNICAL COLLEGE |
| WISE SHOWN OR IN WALLS, CHASE CHAMBERS ON H E. SIZE ONE PIP | ES AND IOT AN | D COL | BOVE CE D WATER | eilinge Supp |). LY TO | | | MTC - SPRINGDALE |
| P SEAL P-TRAP P SEAL IN ACCO PROVIDE PRO " AND INSTALL E OF EQUIPMENT A | ND PIF | CE WITH AP GU STRAIN PING SH | H 2021 (IF ARD "TR NER AT A HALL CO | PC) PLI AP PR ALL FL(MPLY I | UMBING IMER 20R WITH THE | | | HALL RESTROOM - AIRPORT CAMPUS H59-N241-CL |
| G CODE 2021 EE | | | | | | J | | 1260 LEXINGTON DRIVE, COLUMBIA, SC 29170 DRAWING ISSUE |
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| SANITARY WAS SANITARY VEN COLD WATER S HOT WATER PI | DTE PIF IT PIPII PIPING | NG | PTION | | | | | DATE |
| BALL VALVE FLOOR CLEAN 3" FLOOR DRA COLD WATER, HANDICAPPED | AIN HOT WA | | LE) | | | | | DESCRIPTION |
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| | | | IEET DET CCURS | | | TAIL FERENCE SIGNATIC EET DETA AWN | N | DESIGNED BY: DLF DRAWN BY: DLF CHECKED BY: DLF SUBMITTED BY: DLF DATE: JUNE 7, 2023 PROJECT #: 1230236 SHEET TITLE SHEET TITLE |
| | | | 0 SC | 4' ALE: 1/8" | 8' = 1'-0" | 16' | PLAN NORTH | |

CONSTRUCTION DOCUMENTS

MECHANICAL 4403 Broad River Road Columbia, S.C. 29210

(803) 731-9834

dana@mdi9834.com

сомм. No. 233899

SHEET NUMBER

P1

ORIGINAL SHEET SIZE: 22" X 34"

DESIGN

INC.

CONTACT: D. FULMER

GENERAL PLUMBING DEMOLITION NOTES

REFER TO ARCHITECTURAL DEMOLITION PLANS FOR DEMOLITION REQT'S BEYOND THOSE INDICATED ON THESE PLANS AS APPLICABLE. COORD ALL DEMOLITION OF EXISTING MATERIALS, PIPING, ETC. WITH G.C. PRIOR TO START OF CONSTRUCTION TO PREVENT ISSUES.

- DI. CONTRACTOR SHALL FIELD COORDINATE AND VERIFY EXIST CONDITIONS PRIOR TO START OF DEMOLITION WORK. NOTIFY ENGINEER IMMEDIATELY IF QUESTIONS OR CONFLICTS ARE DISCOVERED AT START OF PROJECT.
- D2. PROVIDE SAWCUTTING, CUTTING, CORE DRILLING AND REMOVAL OF EXIST FLOOR SLABS AND/OR EXIST WALLS AS REQUIRED FOR THE DEMOLITION AND INSTALLATION OF EXIST PLUMBING SYSTEMS.

D3. PATCHING OF EXIST FINISHES SHALL BE BY THE GENERAL CONTRACTOR.


EXISTING CEILING NOTE


THE EXISTING SUSPENDED CEILING TILES ARE TO BE REMOVED, STORED AND REINSTALLED BY THE GENERAL CONTRACTOR AS REQUIRED FOR THE INSTALLATION OF PLUMBING SYSTEMS. THE PLUMBING CONTRACTOR SHALL BE RESPONSIBLE FOR ENSURING THAT NO CEILING GRID IS DISTURBED DURING THE INSTALLATION OF ABOVE CEILING PIPING. FAILURE TO COMPLY WITH THIS REQUIREMENT WILL RESULT IN REPLACEMENT OF THE DAMAGED CEILING GRID. ANY COSTS ASSOCIATED WITH A FAILURE TO COMPLY WITH THIS REQUIREMENT WHETHER INTENTIONAL OR ACCIDENTAL SHALL BE THE SOLE RESPONSIBILITY OF THE PLUMBING CONTRACTOR.


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1.1 SCOPE:

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- A. Provide all related equipment, labor, materials, excavation and backfill, operations and accessories required for the installation of complete and quietly operating plumbing systems, in accordance with the plans and specifications. This shall include the following:
 - 1. Soil, Waste, Drain and Vent Piping
 - 2. Domestic Hot and Cold Water Piping
 - 3. Plumbing Fixtures and Trim
 - 4. Floor Drain
 - 5. Air Chambers
 - 6. Cleanouts
 - 7. Valves
 - 8. Pipe Hangers and Supports
 - 9. Pipe Insulation
- 10. Sterilization of Domestic Water Piping and Certificates
- 11. Tests
- 12. Guarantees
- 1.2 EXCAVATION AND BACKFILLING:
 - A. Provide all excavating and backfilling for work under this Division of the contract.
 - B. Upon completion of tests and inspections, backfill with approved material, placed and tamped to prevent excessive settlement.
- 1.3 SOIL, WASTE, DRAIN, SEWER AND VENT PIPE:
 - A. Soil, waste, drain and vent piping shall be sch 40 solid core PVC plastic pipe with solvent cement drainage pattern fittings.
- 1.4 HOT AND COLD WATER PIPING:
- A. Hot and cold water pipe to be hard drawn copper. Type L with soldered wrought copper fittings. Use lead-free hard solder (95-5) for all joints. Use soldering nipples or couplings between screwed and soldered pipe and fittings.
- 1.5 PIPE INSULATION:
 - A. Hot and cold water piping shall be insulated with 1" thick one piece fiberglass insulation with embossed vapor barrier laminated jacket. Pipe fittings shall be insulated with same material and thickness as pipe. Install PVC jacket for all pipe insulation fittings. Insulation shall conform to HH-1-558B, Form D, Type III, Class 12; NFPA 90A and MIL-1-223.
 - B. Piping located in interior walls or chases may be 1/2" thick in lieu of 1" thick noted above.
- 1.6 VALVES:
 - A. Provide lead-free ball valves for hot and cold water piping where noted. Valves shall be sized according to line sizes shown.

3

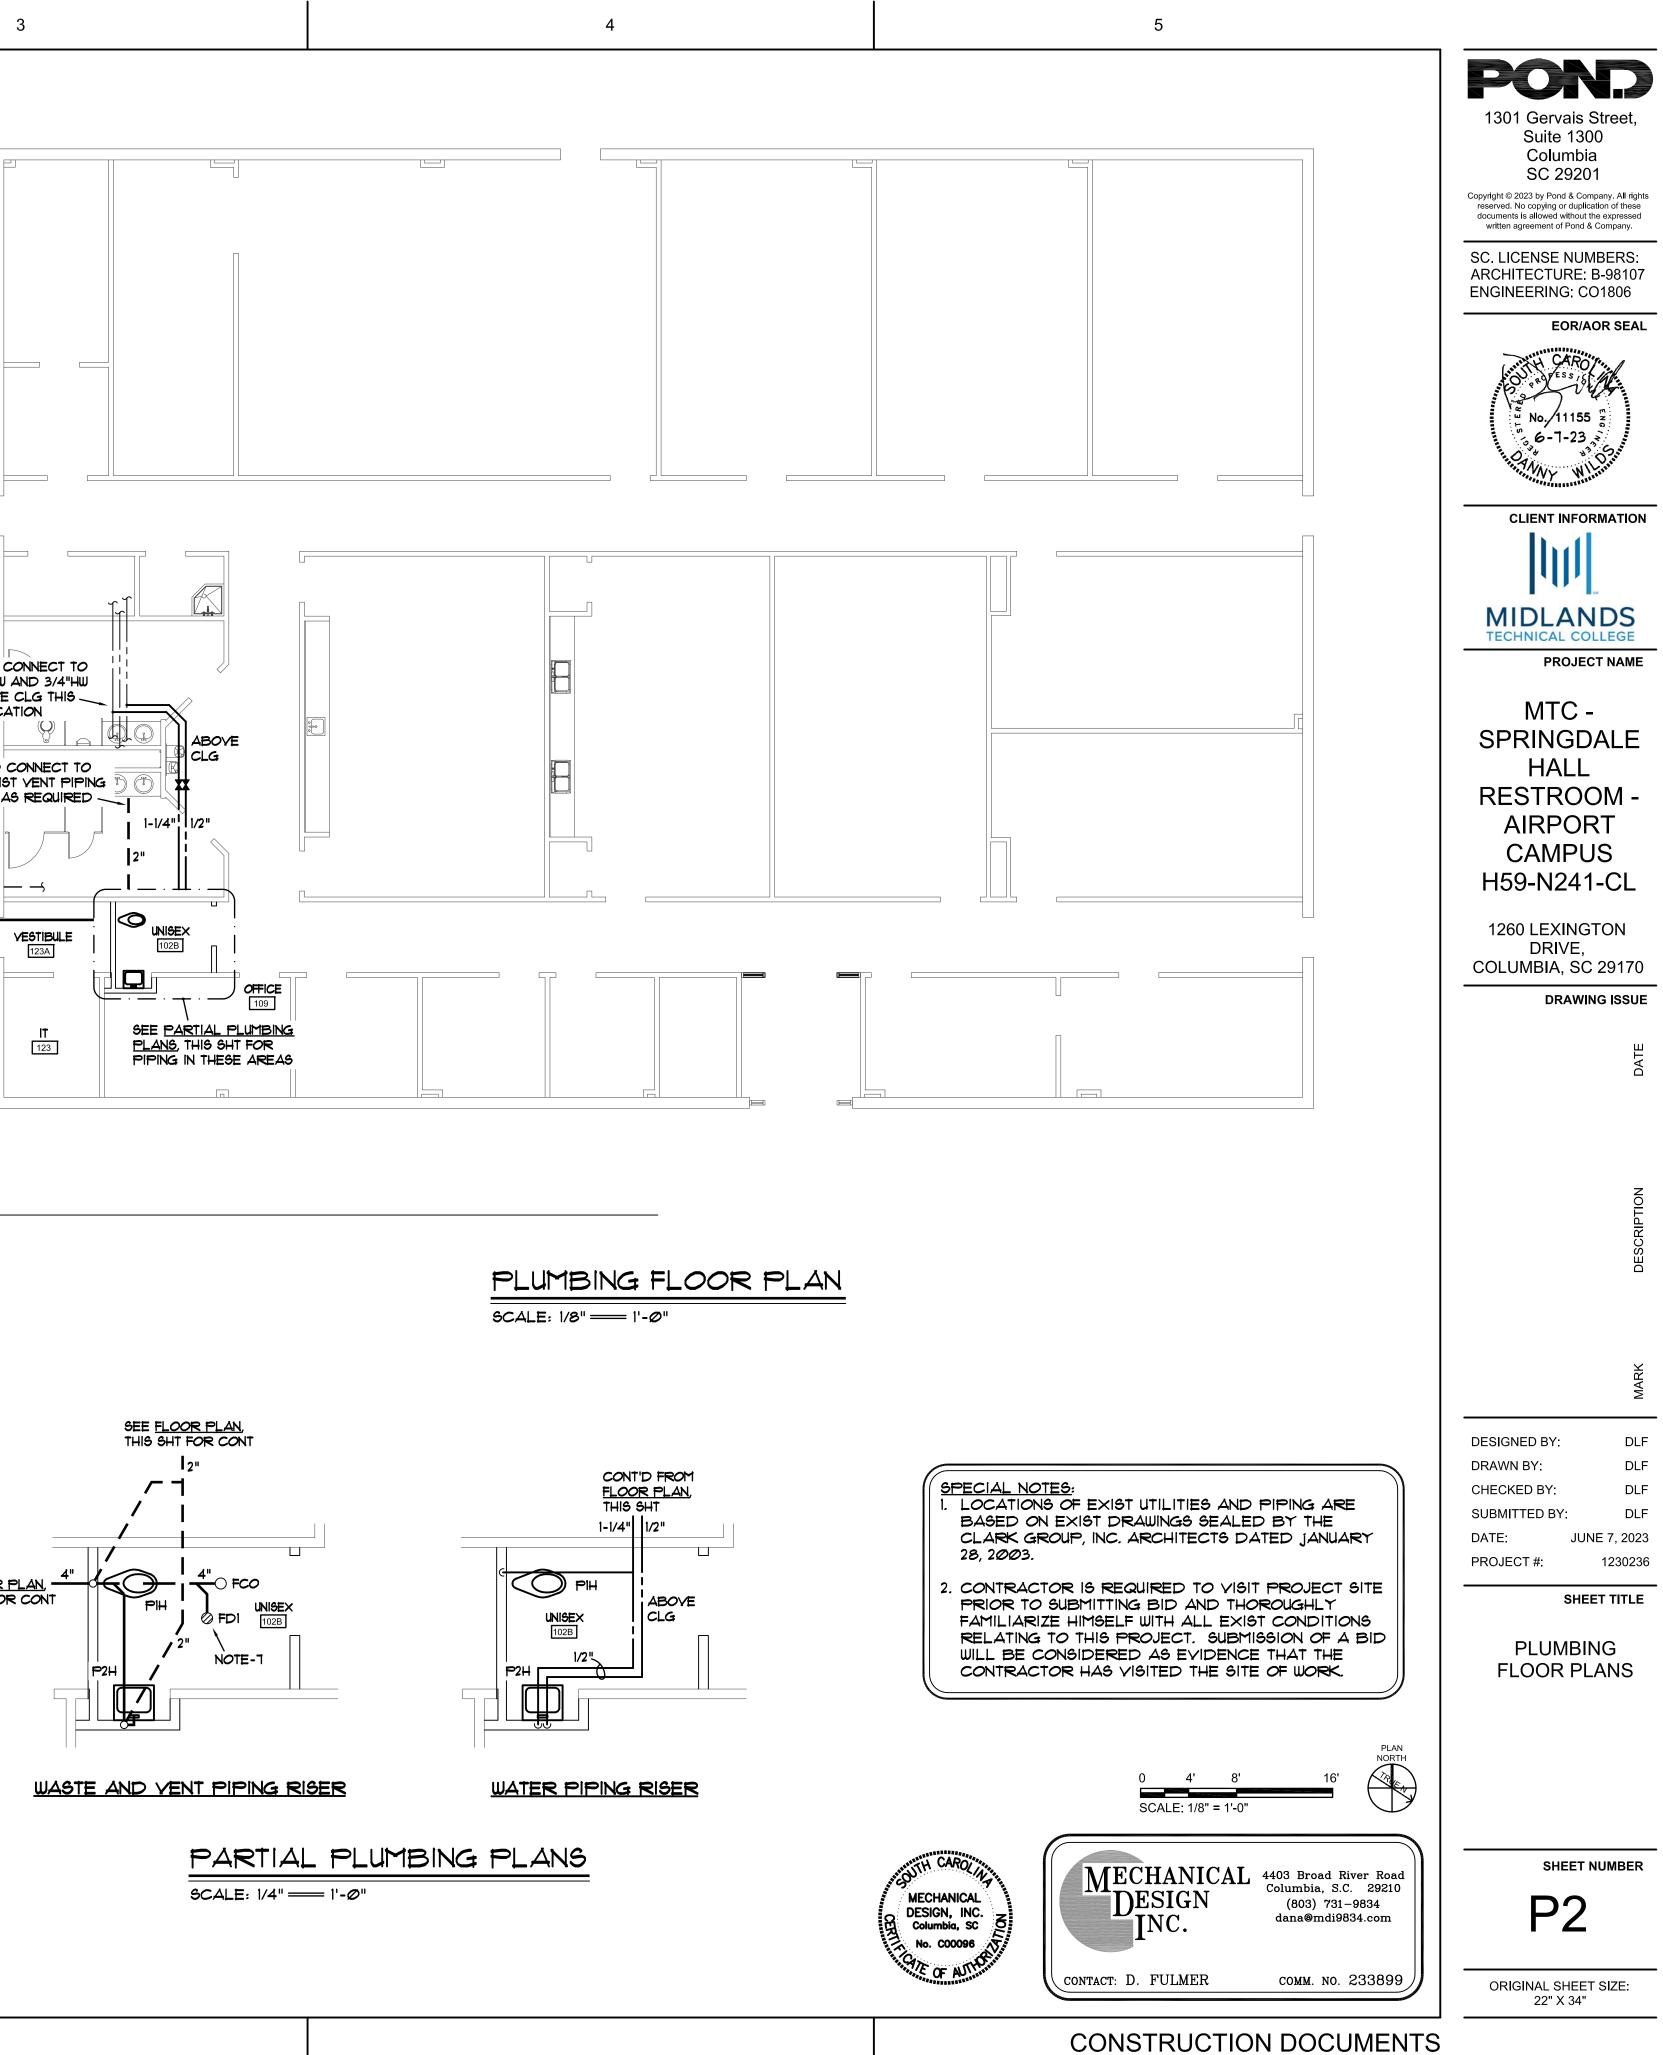PLUMBING SPECIFICATIONS

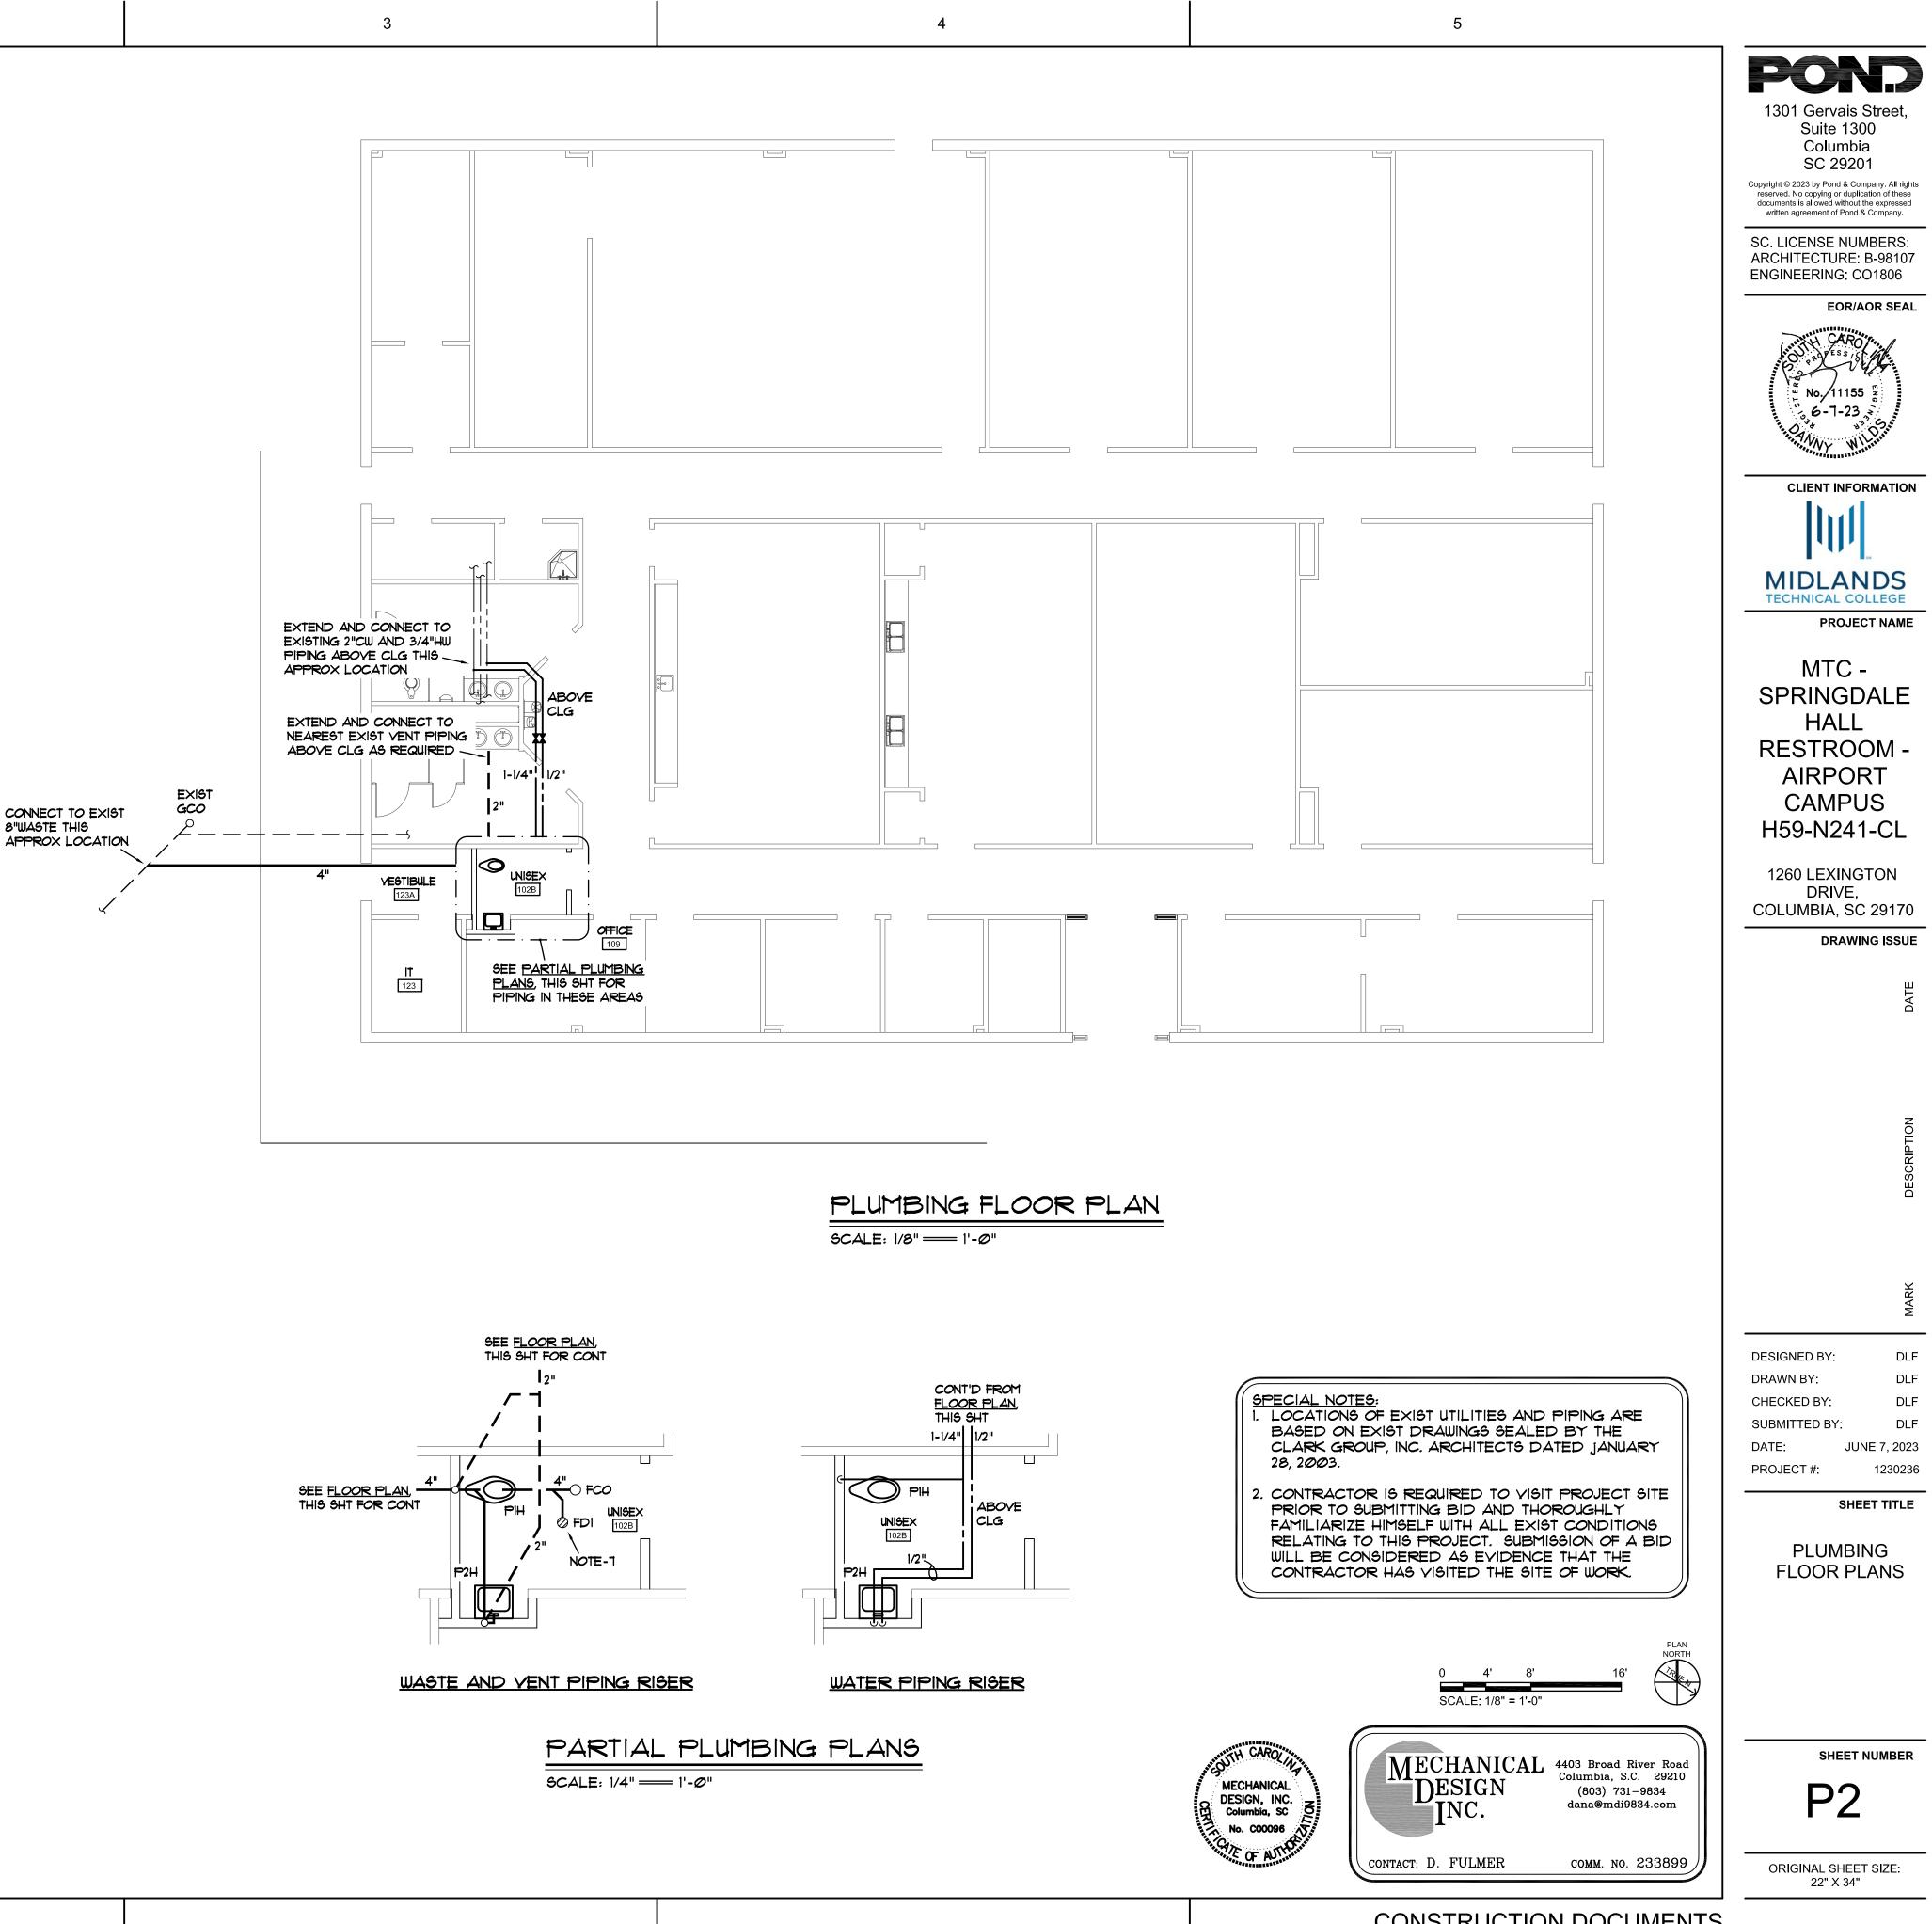B. Ball valves shall be two piece, designed with minimum working pressure of 600 psi with full port, sweat type, chrome plated ball and blow-out proof stem. The manufacturer name and working pressure to be cast on valve body.

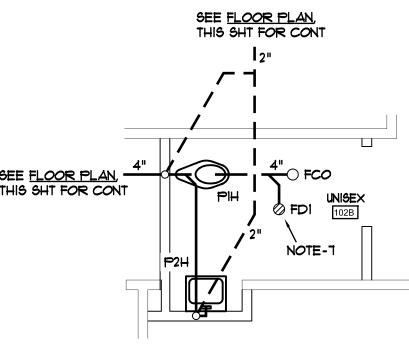- C. Install valves with stems upright within 15 degrees of the vertical plane.
- D. Valve handles shall be malleable iron. Die-cast aluminum handwheels will not be accepted.
- E. Valves to be the product of one of the manufacturers and model numbers shown in the following table or accepted equal:

| <u>Ball Valves</u> | Hammond | Apollo | Nibco |
|-----------------------------------|---------|----------|-------------|
| 2" and smaller (Bronze, Sweat) | UP8311A | 70LF-200 | S-585-80-LF |

- 1.7 FLOOR DRAINS/CLEANOUTS:
- A. Provide cleanout plugs for all cleanouts. Floor drains and cleanouts shall be as manufactured by JR Smith or equal by Josam, Zurn or Wade will be accepted.

(FCO): ZN-1400-BP-NL, with round scoriated nickle-bronze adjustable floor cover and neoprene gasket seal connection. Install top of cover flush with finish floor.

(FD1): ZN-415-7I with 7" diameter extended lip nickle bronze strainer, 3" outlet. Install top of strainer flush with finished <u>floor.</u>

- 1.8 PIPE SUPPORTS:
 - A. Perforated strap hangers, chain or wire will not be permitted on the job.
 - B. Support horizontal piping above around with hangers. threaded rods and turnbuckles as mfd. by Grinnell, Fee and Mason, PHD Hangers, or approved equal.
 - C. Support copper pipe with copper or copper plated hangers, spaced not over 6 feet apart for 1/2" pipe and 8 feet apart for larger pipes.
 - D. Provide seismic restraint products and systems for all overhead piping systems in accordance with local codes and ordinances. Seismic systems shall be as mfr'd by Amber-Booth, Mason Industries or accepted equal.
- 1.9 FIXTURES:
 - A. Provide stop valves for all fixtures as follows: Lavatory (3/8"): McGuire 165 or Brasscraft R1912-A
 - B. Provide 17 ga. C.P. p-trap for lavatories with cleanout as follows:

McGuire 8902 1-1/4"x1-1/2"

- C. Fixtures shall be as mfr'd by Kohler or equal by American Standard or Zurn will be accepted.
- D. Toilet seats shall be as mfr'd by Beneke or equal by Bemis, Olsonite or Church will be accepted.
- E. Faucet shall be as manufactured by Sloan to match existing. or equal by Delta or Moen.

F. Plumbing fixtures shall be as specified below:

P1H Hdc'd Water Closet; K-96057, 16-5/8" high elongated siphon jet floor mounted water closet, Sloan Regal 111-SFSM-1.6 battery powered infrared sensor activated flush valve with cast brass setscrew escutcheon, Bemis 1655SSCT white open front seat. less cover and bolt caps.

P2H Hdc'd Wall Hung Lavatory; Kohler K-2867-ZW-O, 20"x18" wall hung cast iron lavatory with wall lock-down lugs, 4" centers, Sloan SF-2350-BDM battery powered sensor faucet with below deck mechanical mixing valve, vandal proofing and McGuire 155A grid strainer.

A. Sterilize with a solution containing not less than (50) parts per million of available chlorine. Use sodium hypochlorite solution conforming to Federal Specifications OB-441-A, Grade D. Solution to remain in system for (24) hours, opening and closing all valves several times. After sterilization, flush with clean water until chlorine is not areater than 0.2 parts per million.

C. After the (24) hour retention period of the disinfection solution, the treated water should contain no less than 25 mg/l chlorine throughout the length of pipe.

- 1.11 TESTS:

B. Test entire waste, and sanitary drainage and venting pipe systems by plugging all necessary openings and filling systems with minimum 10'-0" water column, or to the top of the highest vent stack.

1.12 GUARANTEE:

- Contractor.
- year satisfactory service.

4

1.10 STERILIZATION OF HOT AND COLD WATER SYSTEMS:

B. Have samples collected from throughout the systems on (2) consecutive days tested by an approved independent testing laboratory and deliver certificates of approval to County Sanitarian, and Owner. All laboratory fees shall be included in the plumbing contract. Contractor shall be responsible for preventing use of water from systems for human consumption until tested and approved. Should any of the tests prove unfavorable, the entire disinfection and sampling process shall be repeated.


D. Certificates indicating negative results of bacteriological tests shall be procured prior to building acceptance.


A. Pressure and leak test all water piping at minimum 150 PSI for 4 hours and in accordance with local requirements.

A. Contractor shall guarantee all equipment, piping and any other materials specified under this Division of the contract for a period of one (I) year from the date of project acceptance unless otherwise indicated. Upon failure of any part(s) of the system during the guarantee period, the affected part(s) shall be repaired or replaced promptly by and at the expense of the

B. If any component fails during the regular one year period, then the replacement part(s) shall be given an additional one (I) year guarantee from the time of replacement. This shall continue until the items have given one (I)

END OF PLUMBING SPECIFICATIONS

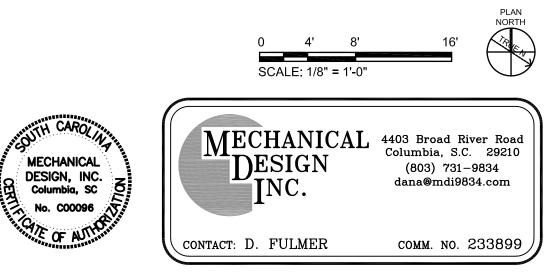

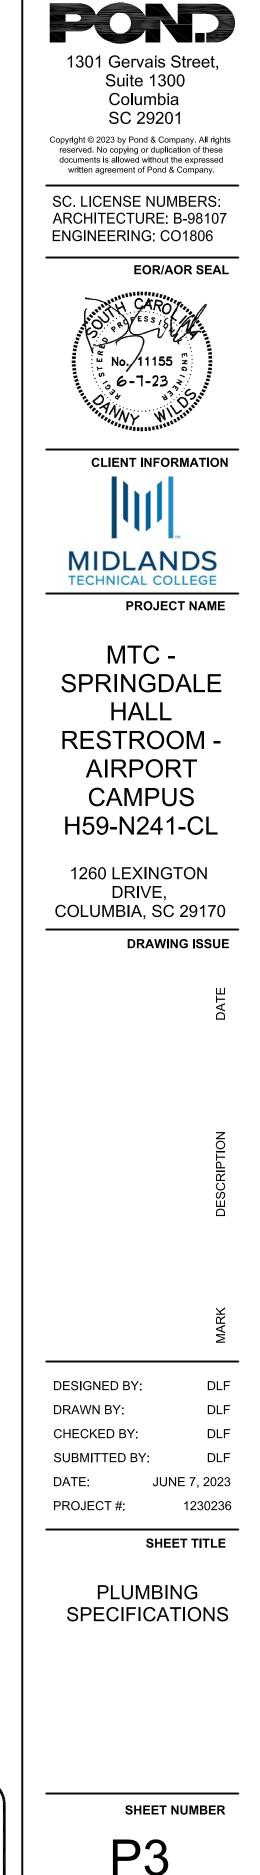

ORIGINAL SHEET SIZE: 22" X 34"

CONSTRUCTION DOCUMENTS


| | VENTILATING FAN SCHEDULE | | | | | | | | | |
|---------|--------------------------|-----|-------------|-----------------|-------|--------|------------------|--|--|--|
| MARK | GREENHECK (2) MODEL | CFM | FAN S.P. | MOTOR SIZE 3 | SONES | DRIVE | CONTROLLED BY | | | |
| CEF (4) | 5P-80-VG () | 75 | 1/4" | IØ WATTS | 1.Ø | DIRECT | SEE ELECTRICAL | | | |
| | | | | | | | | | | |

(1) FANS TO MATCH AVAILABLE ELECTRICAL SERVICE, SEE ELECTRICAL

(2) OR EQUAL BY COOK, BREIDERT, CARNES, TWIN CITY, PENN OR APPROVED EQUAL

(3) PROVIDE EC MOTOR

(4) PROVIDE WITH ALUMINUM EGG CRATE GRILLE, DISCONNECT, BACKDRAFT DAMPER, INSECT SCREEN, AND WL LOUVER

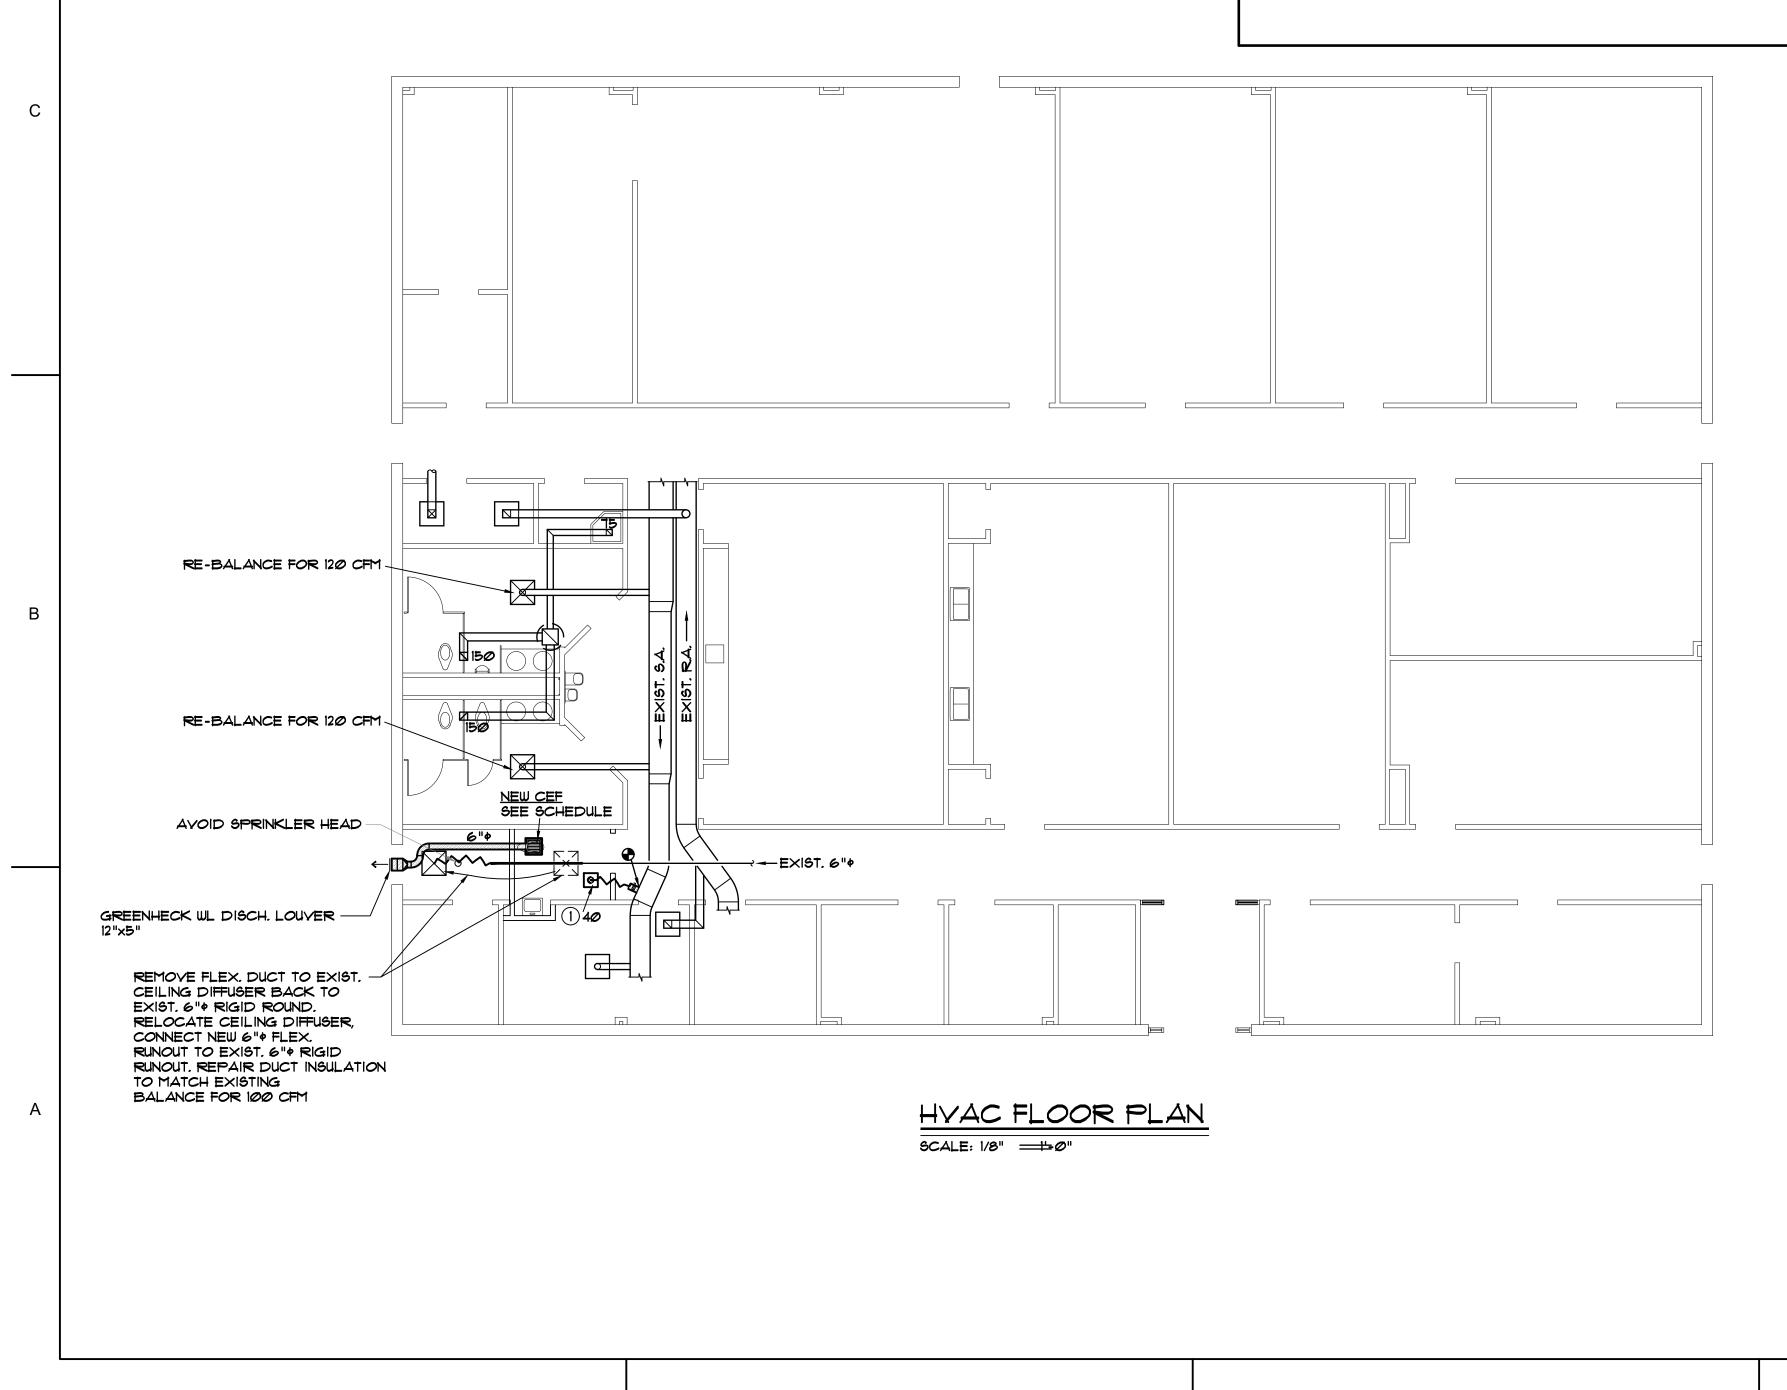

D

| 3 | 4 |
|---|---|
| | |


| | GRILLE AND DIFFUSER SCHEDULE | | | | | | | | |
|----------------------------|---|-----------------|----------------------|----------------|-----------------------|---------------------|--|--|--|
| MARK | SERVICE | NECK SIZE | MAX CFM | RUNOUT SIZE | T REMARKS | | | | |
| | SUPPLY | 6"¢ | 110 | 6"\$ | " W/ BUTTERFLY DPR. | | | | |
| | | | | | | | | | |
| GRIL DI ff u | | CEILING TYPE | TITUS * MODEL NO. | | | MATERIAL | | | |
| SQUARE | SQUARE SUPPLY LAY-IN PAS-3 (PERFORATED, FLUSH FACE) | | | | POWDER COATED STEEL | | | | |
| SQUARE | SUPPLY | GYP. BD. | PAS- | I (PERFORA | ATED) | POWDER COATED STEEL | | | |
| | | | | | | | | | |
| | | | | | | | | | |


* OR EQUAL BY PRICE, METALAIRE, NAILOR, KREUGER, OR APPROVED EQUAL


NOTES: 1. GRILLE AND DIFFUSER LOCATIONS SHOWN ON FLOOR PLANS ARE APPROXIMATE, SEE ARCHITECTURAL REFLECTED CEILING PLAN FOR EXACT LOCATION.

> 2. GRILLES AND DIFFUSERS SHALL MATCH CEILING TYPE, SEE ARCHITECTURAL DRAWINGS FOR CEILING TYPE.

3. GRILLE AND DIFFUSER COLORS SHALL BE SELECTED BY ARCHITECT, SUBMIT COLOR SAMPLES TO ARCHITECT.

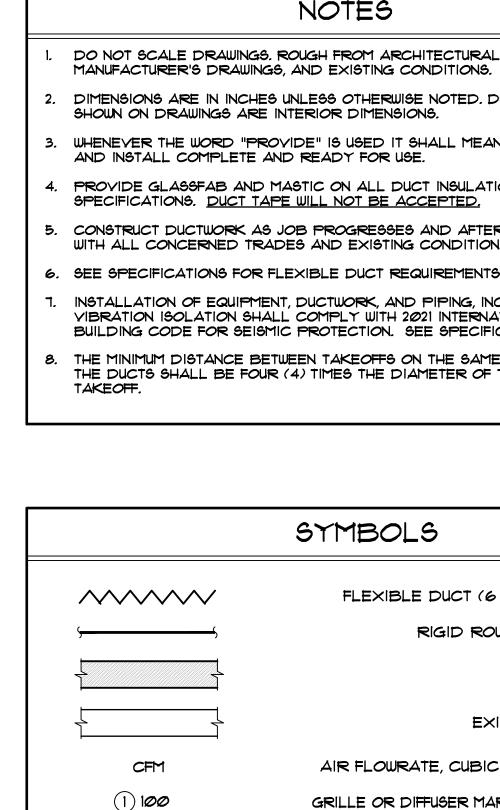

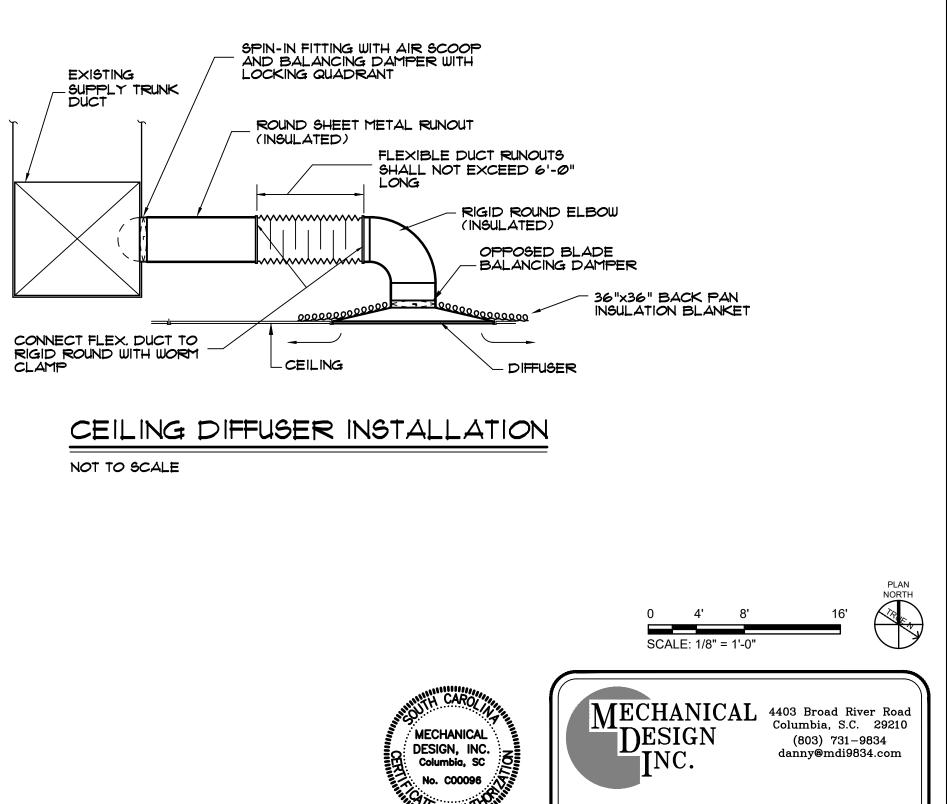

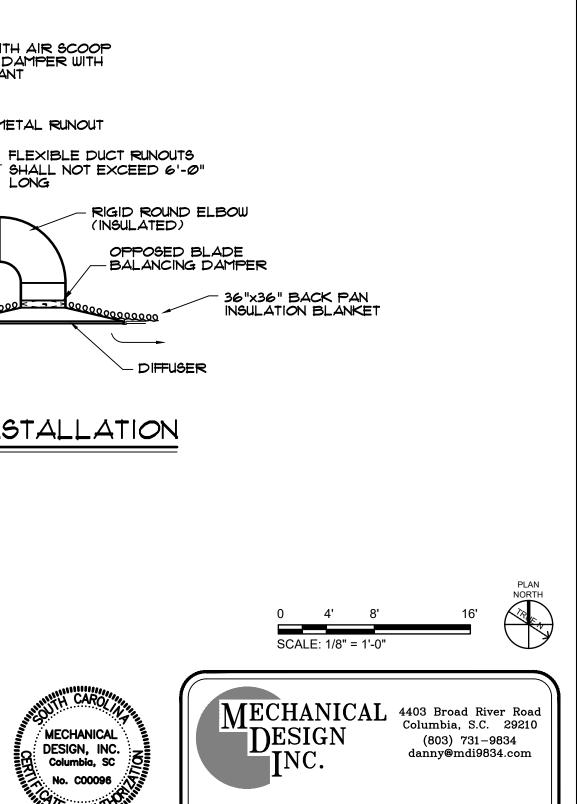

CONTACT: Danny Wilds

NOTES

- DO NOT SCALE DRAWINGS. ROUGH FROM ARCHITECTURAL, EQUIPMENT
- 2. DIMENSIONS ARE IN INCHES UNLESS OTHERWISE NOTED. DUCT SIZES SHOWN ON DRAWINGS ARE INTERIOR DIMENSIONS.
- 3. WHENEVER THE WORD "PROVIDE" IS USED IT SHALL MEAN FURNISH AND INSTALL COMPLETE AND READY FOR USE.
- 4. PROVIDE GLASSFAB AND MASTIC ON ALL DUCT INSULATION, SEE SPECIFICATIONS. DUCT TAPE WILL NOT BE ACCEPTED.
- 5. CONSTRUCT DUCTWORK AS JOB PROGRESSES AND AFTER COORDINATING WITH ALL CONCERNED TRADES AND EXISTING CONDITIONS.
- 6. SEE SPECIFICATIONS FOR FLEXIBLE DUCT REQUIREMENTS.
- INSTALLATION OF EQUIPMENT, DUCTWORK, AND PIPING, INCLUDING VIBRATION ISOLATION SHALL COMPLY WITH 2021 INTERNATIONAL BUILDING CODE FOR SEISMIC PROTECTION. SEE SPECIFICATIONS,
- 8. THE MINIMUM DISTANCE BETWEEN TAKEOFFS ON THE SAME SIDE OF THE DUCTS SHALL BE FOUR (4) TIMES THE DIAMETER OF THE FIRST

SYMBOLS

FLEXIBLE DUCT (6 FT. MAX. LENGTH)

RIGID ROUND RUNOUT DUCT

NEW MATERIAL

EXISTING MATERIALS

AIR FLOWRATE, CUBIC FEET PER MINUTE GRILLE OR DIFFUSER MARK, BALANCING CFM

SPIN-IN TAKEOFF WITH SCOOP AND DAMPER

CONSTRUCTION DOCUMENTS

сомм. No. 233899

| POND |
|--|
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| SC. LICENSE NUMBERS: ARCHITECTURE: B-98107 ENGINEERING: CO1806 |
| EOR/AOR SEAL |
| |
| MIDLANDS TECHNICAL COLLEGE |
| MTC - SPRINGDALE HALL RESTROOM - |
| AIRPORT CAMPUS |
| H59-N241-CL |
| DRIVE, COLUMBIA, SC 29170 |
| DRAWING ISSUE |
| DATE |
| DESCRIPTION |
| MARK |
| DESIGNED BY: DW DRAWN BY: DW CHECKED BY: DW SUBMITTED BY: DW DATE: JUNE 7, 2023 PROJECT #: 1230236 |
| SHEET TITLE HVAC FLOOR PLAN, SCHEDULES AND DETAILS |
| |
| |

M101

ORIGINAL SHEET SIZE: 22" X 34"

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|---|---|---|
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| В | | |
| A | | |
| | | |

MECHANICAL SPECIFICATIONS

4


| 1.0 | GENERAL |
|------|--|
| 1.1 | All material and work shall comply with the National Fire Codes of the NFPA, National and local codes and the 2021 International Building Code, 2021 International Mechanical Code, 2021 International. Plumbing Code, 2009 International Energy Conservation Code, ASHRAE Standard 90.1 – 2007 and 2020 National Electric Code. |
| 1.2 | Drawings for work under Division 23 are diagrammatic and generally, indicate reasonable arrangements. Work under Division 23 includes all work necessary to make HVAC systems complete and fully operational. |
| 1.3 | MATERIAL AND EQUIPMENT SUBMITTALS: Submit for review detailed drawings of all equipment and all material listed in this section. All submittal data shall be bound in a hardback binder. Partial submittals will not be reviewed by the Engineer . Furnish six (6) copies of equipment submittals. Review rendered on equipment submittals shall not be considered as a guarantee of measurements of building conditions. WHERE DRAWINGS ARE REVIEWED, SAID REVIEW DOES NOT MEAN THAT DRAWINGS HAVE BEEN CHECKED IN DETAIL; SAID REVIEW DOES NOT IN ANY WAY R RELIEVE THE CONTRACTOR FROM HIS RESPONSIBILITY OR NECESSITY OF FURNISHING MATERIAL OR PERFORMING WORK AS REQUIRED BY THE CONTRACT DOCUMENTS. Partial submittals will not be reviewed by the Engineer. Submit for the following materials and equipment for review by the Engineer: |
| | 1. Ceiling Exhaust Fan, 2. Grilles and Diffusers, |
| 1.4 | WORKMANSHIP: Work that is not of good quality will require removal and reinstallation. |
| 1.5 | COORDINATION: No work shall be performed on this project before thoroughly coordinating all space requirements for pipes, control panels, and control components with all trades concerned and existing conditions. Temperature and equipment control wiring is included under Division 23. |
| 1.6 | The responsibility for obtaining, cutting, and patching for work under Division 23 of the specifications is included Division 23. |
| 1.7 | DAMAGES DURING CONSTRUCTION: Contractor shall be responsible for any costs of repairing any damages caused by this contractor, to the building, building contents, and site during construction and warranty period. |
| 1.8 | WARRANTY: Warrant all control components, piping and any other materials specified under Division 23. Warrant all equipment, ductwork, piping and any other materials specified under Division 23 for a period of one (I) year from the date of project acceptance unless otherwise indicated. Upon failure of any part(s) of the system during the warranty period, the affected part(s) shall be repaired or replaced promptly by and at the expense of the Contractor. |
| 1.9 | IDENTIFICATION: Identify each piece control component. Items shall be identified by name and numerical sequence. Nameplates shall be 1/16" thick plates with 1/2" high white letters on black background. Nameplates shall be attached securely with screws, not glued. |
| 1.10 | RECORD DRAWINGS: Provide record drawings for all work included in Division 23. Maintain on the job site one complete set of drawings for this project. All changes authorized by the Engineer and/or Owner as to locations, sizes and routing of equipment, ductwork, piping and other material shall be indicated in red ink on the drawings as work progresses. Before Final Completion, Contractor shall obtain the latest set of AutoCad drawings from the Engineer which shall include the information outlined above. AutoCad drawings (including schedules, details, and sections) shall be corrected to depict all substituted materials and equipment. |
| 2.0 | SEISMIC REQUIREMENTS: All materials shall comply with the 2021 International Building Code (IBC) for seismic requirements. |
| 2.1 | Provide seismic submittals including calculations to determine restraint loads resulting from seismic forces presented in IBC. Seismic calculations shall be certified and stamped by a Structural Engineer in the employ of the seismic equipment manufacturer with a minimum of 5 years experience, and licensed in the project's jurisdiction. |
| 2.2 | Provide seismic calculations and submittals for all new roof mounted equipment. |
| 2.3 | Manufacturers of seismic restraints must be a member of the Vibration Isolation and Seismic Control Manufacturers Association (VISCMA). |
| 2.4 | Provide letter of acceptance from the manufacturer's agent prior to project closeout indicating manufacturer review of installed seismic restraints for new equipment throughout project. |

- 3.0 TESTING, ADJUSTING, AND BALANCING3.1 Work under this section includes the
- balancing of all new heating, ventil systems. The results of all tests, a shall be submitted to the Engineer
- 3.2 Instruments used shall be of high of AABC or NEBB for the application. calibrated and certified within the l
- 3.3 The balancing firm shall warrant, sol set to within 10% of the values as and specifications and also adjust areas. The testing, balancing and as many times as required to prov met. If requested by the Engineer, in his presence.
- 3.4 Any changes that are required for the determined by the balancing firm she section of the specifications. Such cl not limited to, changing of pulleys, t dampers or access panels.
- 3.5 Prior to acceptance of the systems b Engineer for his review, a written tes balancing report, in triplicate, contain ring notebook. All reports, forms an generally be the standards of AABC
- 4.0 INSULATION
- 4.1 New supply air ducts shall be insue equal to Mansville Microlite "Common R-6.0 min. with FRK vapor barrie ducts with bonding adhesive.
- 5.0 DUCTWORK
- 5.1 Coordinate routing of new ducts with trades in the field. Provide offsets a existing structural and any other inte ducts until all space requirements ho with all other trades and existing co
- 5.2 New supply, return, exhaust and o constructed in strict accordance v Standards. A copy of the SMACNA shall be kept on the job site. A sheet metal, 26 gauge minimum.
- 5.3 New flexible supply air ducts to ce 1" thick U.L. 181 Class 1 Air Duc locking sheet metal end rings for and ceiling diffusers. Maximum r six feet (6').
- 5.4 Supply air duct take—offs from sh factory fabricated fitting with an screw holes at each quadrant, air with locking mechanism. The fitti trunk with sheet metal screws an
- 5.5 Support ducts from the building su sheet metal hangers on eight foo change in direction. Flexible duct foot (3') centers. Crimping or sc be accepted.
 - END OF DIVISION 23 HVAC

3

| | POND 1301 Gervais Street, Suite 1300 Columbia SC 29201 |
|---|--|
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| G ne testing, adjusting and ilating and air conditioning adjustments and balancing r for approval. quality and as recommended by Instruments shall be properly last six months. | EOR/AOR SEAL |
| colely that the system will be as established by the drawings to minimize drafts in all d adjusting shall be performed ove project requirements have been er, tests shall be performed the final balancing results as | CLIENT INFORMATION |
| shall be provided under this changes shall include, but belts, dampers or adding by the Owner, submit to the esting, adjusting and bined in a hard-backed three and data sheets shall c or NEBB. | MIDLANDS TECHNICAL COLLEGE PROJECT NAME MTC - |
| sulated with 2" thick duct wrap nmercial Grade", 1 Ib density, ier. Adhere to clean sheet metal | SPRINGDALE HALL RESTROOM - AIRPORT |
| h existing conditions and other and vary sizes as required to avoid Iterferences. Do not construct any have been thoroughly coordinated conditions. | CAMPUS H59-N241-CL |
| outside air supply ducts shall be with SMACNA Low Pressure Duct VA Low Pressure Duct Standards All new ducts shall be galvanized N. ceiling diffusers shall be minimum | 1260 LEXINGTON DRIVE, COLUMBIA, SC 29170 DRAWING ISSUE |
| uct. Each section shall have or connection to take—off fittings run of flexible ducts shall be sheet metal trunks shall be a | DATE |
| adhesive backed collar and air scoop, and balancing damper tting shall be secured to the and coated with duct sealant. structure with 1" wide galvanized bot (8') centers and at each | |
| icts shall be supported on three sagging of flexible ducts will not | DESCRIPTION |
| | MARK |
| | DESIGNED BY: DW DRAWN BY: DW CHECKED BY: DW SUBMITTED BY: DW DATE: JUNE 7, 2023 PROJECT #: 1230236 SHEET TITLE |
| | HVAC SPECIFICATIONS |
| 0 4' 8' 16' | |
| MECHANICAL DESIGN, INC. Columbia, SC No. C00096 | sheet number |
| CONTACT: Danny Wilds COMM. NO. 233899 | ORIGINAL SHEET SIZE: 22" X 34" |

CONSTRUCTION DOCUMENTS

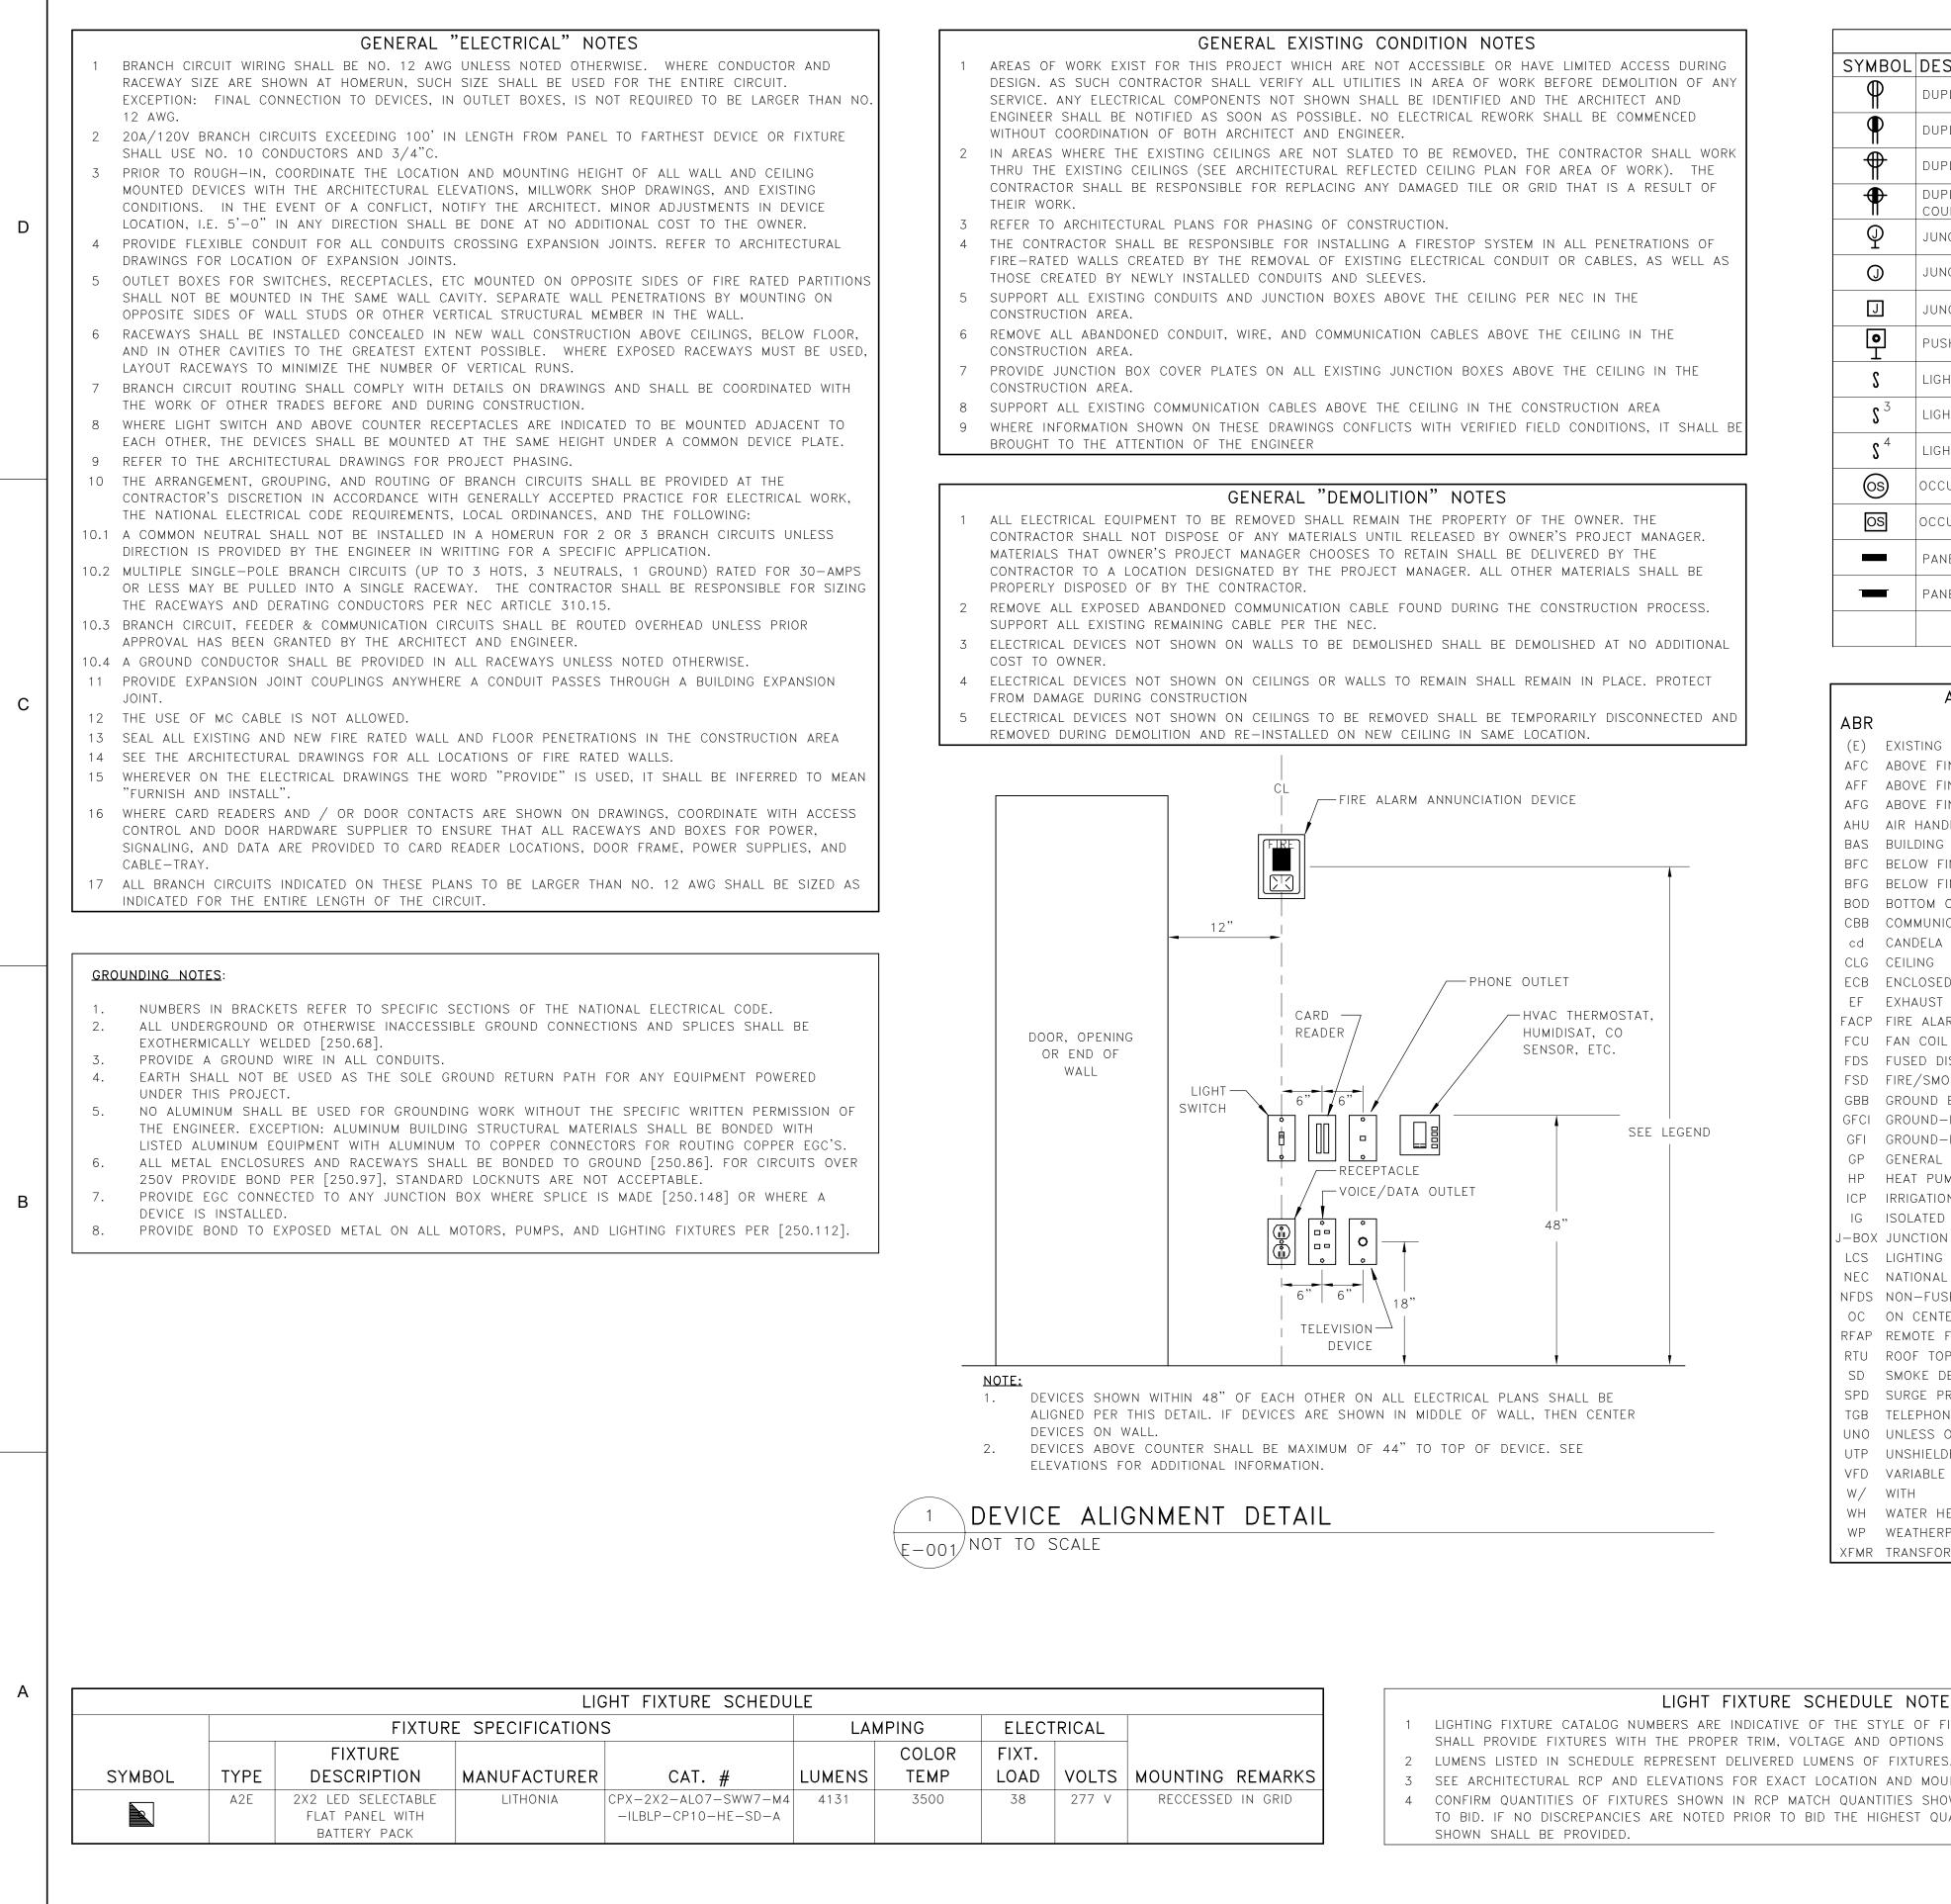

3

| |] | OS | OCCUPANCY SENSOR (CEILING MOUNTED) |
|--------|---|--------|------------------------------------|
| R. | | OS | OCCUPANCY SENSOR (WALL MOUNTED) |
| BE | | | PANELBOARD (SURFACE MOUNTED) |
| SS. | | | PANELBOARD (RECESS MOUNTED) |
| IONAL | | | |
| IONAL | | | |
| ECT | | | ABBREVIATIONS |
| ED AND | | ABR | DESCRIPTION |
| | | (E) E> | (ISTING |
| | | AFC AE | BOVE FINISHED CEILING |
| | | AFF AE | BOVE FINISHED FLOOR |
| | | AFG AE | BOVE FINISHED GRADE |
| | | AHU AI | R HANDLING UNIT |
| | | BAS BU | JILDING AUTOMATION SYSTEM |
| | | | |

| BAS | BUILDING AUTOMATION SYS |
|-----|-------------------------|
| BFC | BELOW FINISHED CEILING |
| BFG | BELOW FINISHED GRADE |
| BOD | BOTTOM OF DEVICE |
| | CONTRACTORS DAOK DO |

CBB COMMUNICATIONS BACK BOARD

cd CANDELA CLG CEILING

- ECB ENCLOSED CIRCUIT BREAKER
- EF EXHAUST FAN FACP FIRE ALARM CONTROL PANEL
- FCU FAN COIL UNIT
- FDS FUSED DISCONNECT SWITCH
- FSD FIRE/SMOKE DAMPER GBB GROUND BUSS BAR
- GFCI GROUND-FAULT CIRCUIT-INTERRUPTING
- GFI GROUND-FAULT INTERRUPTING
- GP GENERAL PURPOSE
- HP HEAT PUMP
- ICP IRRIGATION CONTROL PANEL IG ISOLATED GROUND
- J-BOX JUNCTION BOX
- LCS LIGHTING CONTROL SYSTEM
- NEC NATIONAL ELECTRIC CODE
- NFDS NON-FUSED DISCONNECT SWITCH
- OC ON CENTER RFAP REMOTE FIRE ALARM ANNUNCIATOR PANEL
- RTU ROOF TOP UNIT
- SD SMOKE DETECTOR
- SPD SURGE PROTECTION DEVICE
- TGB TELEPHONE GROUNDING BUSS BAR
- UNO UNLESS OTHERWISE NOTED UTP UNSHIELDED TWISTED PAIR
- VFD VARIABLE FREQUENCY DRIVE
- w/ with
- WH WATER HEATER
- WP WEATHERPROOF XFMR TRANSFORMER

- LIGHT FIXTURE SCHEDULE NOTES LIGHTING FIXTURE CATALOG NUMBERS ARE INDICATIVE OF THE STYLE OF FIXTURE REQUIRED. CONTRACTOR SHALL PROVIDE FIXTURES WITH THE PROPER TRIM, VOLTAGE AND OPTIONS NECESSARY FOR INSTALLATION.
- 3 SEE ARCHITECTURAL RCP AND ELEVATIONS FOR EXACT LOCATION AND MOUNTING HEIGHTS.
- 4 CONFIRM QUANTITIES OF FIXTURES SHOWN IN RCP MATCH QUANTITIES SHOWN ON ELECTRICAL PLANS PRIOR TO BID. IF NO DISCREPANCIES ARE NOTED PRIOR TO BID THE HIGHEST QUANTITY OF EACH FIXTURE TYPE

JUNCTION BOX (WALL MTD)

JUNCTION BOX (FLOOR MOUNTED)

JUNCTION BOX (CEILING)

PUSH BUTTON CONTROL

LIGHT SWITCH, SINGLE POLE

LIGHT SWITCH, 3 WAY TYPE

LIGHT SWITCH, 4 WAY TYPE

DUPLEX RECEPTACLE (WALL MOUNTED @ 18"AFF)

DUPLEX RECEPTACLE (GFI TYPE @ 18"AFF)

DUPLEX RECEPTACLE (@ 6" ABOVE COUNTER)

DUPLEX RECEPTACLE (GFI TYPE @ 6" ABOVE

SYMBOL DESCRIPTION

COUNTER)

 \bigcirc

IJ


ELECTRICAL

| _ · · · · | YMBOL LEGEND SYMBOL DESCRIPTION | | |
|------------|---|--|--|
| SIMBOL | | | |
| F | FIRE ALARM PULL STATION (WALL MOUNTED @ 48" AFF TOP OF BOX) | | |
| A | FIRE ALARM AUDIBLE DEVICE (WALL MOUNTED @ 7'-6" AFF) | | |
| V | FIRE ALARM VISUAL DEVICE (WALL MOUNTED @ 7'-6" AFF) | | |
| | FIRE ALARM AUDIBLE/VISUAL DEVICE (WALL MOUNTED @ 7'-6" AFF) | | |
| А | FIRE ALARM AUDIBLE DEVICE (CEILING MOUNTED) | | |
| V | FIRE ALARM VISUAL DEVICE (CEILING MOUNTED) | | |
| A/V | FIRE ALARM AUDIBLE/VISUAL DEVICE (CEILING MOUNTED) | | |
| S | SMOKE DETECTOR (WALL MOUNTED) | | |
| (5) | SMOKE DETECTOR (CEILING MOUNTED) | | |
| R | SECURITY CARD READER SEE ACCESS CONTROL DETAILS FOR ADDITIONAL INFO | | |
| | CCTV CAMERA (WALL MOUNTED) SEE COMMUNICATIONS RISER FOR ADDITIONAL INFO | | |
| | CCTV CAMERA (CEILING MOUNTED) SEE COMMUNICATIONS RISER FOR ADDITIONAL INFO | | |
| | CONTROL PANEL (SURFACE MOUNTED) | | |
| | CONTROL PANEL (RECESS MOUNTED) | | |
| 2 a | LOWER CASE SUBSCRIPT INDICATES SWITCH-LEG | | |
| # | KEY NOTE CALLOUT (REFER TO KEY NOTES ON SHEET) | | |

DEMOLITION/RENOVATION NOTATION


- * IF NO ANNOTATION IS SHOWN ASSUME EXISTING TO REMAIN IN PLACE FOR SOLID LINES AND DEMOLISH FOR DASHED LINES. * DEVICES AND EQUIPMENT NOT SHOWN SHALL BE ASSUMED TO
- BE EXISTING TO REMAIN IN PLACE.
- E EXISTING FIXTURE OR DEVICE TO REMAIN IN PLACE. R EXISTING FIXTURE OR DEVICE TO BE REMOVED BY THE ELECTRICAL CONTRACTOR. MAINTAIN CONTINUITY OF REMAINING PORTIONS OF BRANCH CIRCUIT.
- RE EXISTING DEVICE TO BE REMOVED BY THE ELECTRICAL CONTRACTOR. EXISTING CIRCUIT SHALL BE RETAINED. PROVIDE NEW DEVICE AS SHOWN ON RENOVATION PLANS. RN RELOCATED FIXTURE (NEW LOCATION).
- RR EXISTING FIXTURE TO BE RELOCATED BY THE ELECTRICAL CONTRACTOR TO NEW LOCATION SHOWN ON RENOVATION PLAN.

| | ELECTRICAL DRAWING INDEX |
|-------|----------------------------|
| # | SHEET NAME |
| E-001 | ELECTRICAL NOTES & LEGENDS |
| E-101 | ELECTRICAL PLANS |

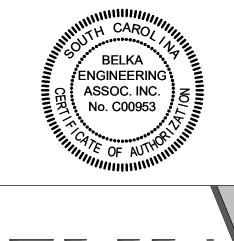



PD2230⁻

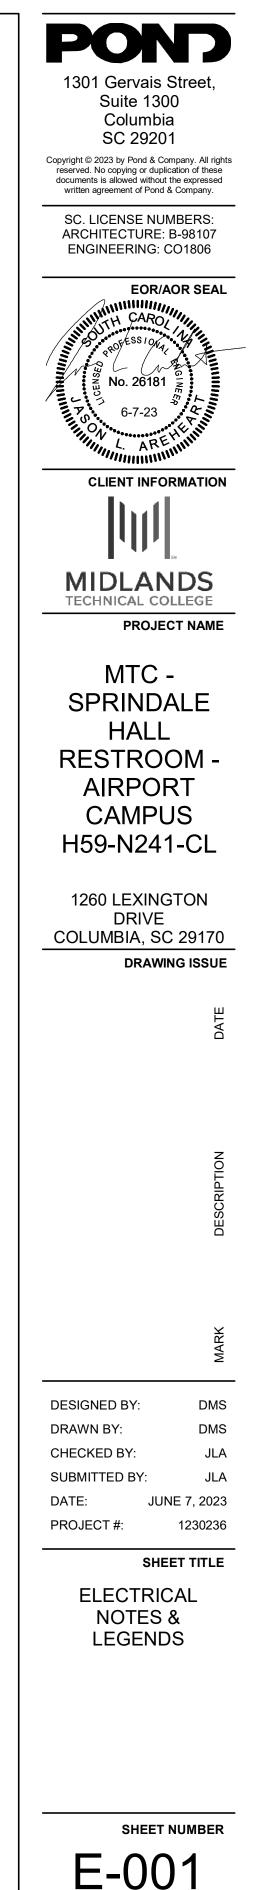

ORIGINAL SHEET SIZE:

22" X 34"

